# Nasoya Foods USA LLC PULMUONE Co., LLC Nasoya Food Factory Expansion and Renovation Project

100 NICKERSON RD MARLBOROUGH, MA 01752 TEL: (508) 786-2200 TETRATECH

**CLIENT INFORMATION:** 

Nasoya Foods USA LLC PULMUONE Co., LLC 2315 Moore Ave. Fullerton, CA 92833

MASSACHUSETTS CORPORATION ID No. 954578431

www.tetratech.com

PROJECT LOCATION:
Nasoya Foods USA LLC
PULMUONE Co., LLC
One New England Way
AYER, MA 01432

TETRA TECH PROJECT No.:

PROJECT DESCRIPTION / NOTES:


EXPANSION AND ADDITION TO THE EXISTING NASOYA AYER TOFU PRODUCTION FACILITY.


ISSUED:

127-280495-24001

08 APR 24 - PICK & PACK PERMIT

SITE DEVELOPMENT PLANS APPLICATION FOR MINOR MODIFICATION TO THE SITE PLAN PERMIT

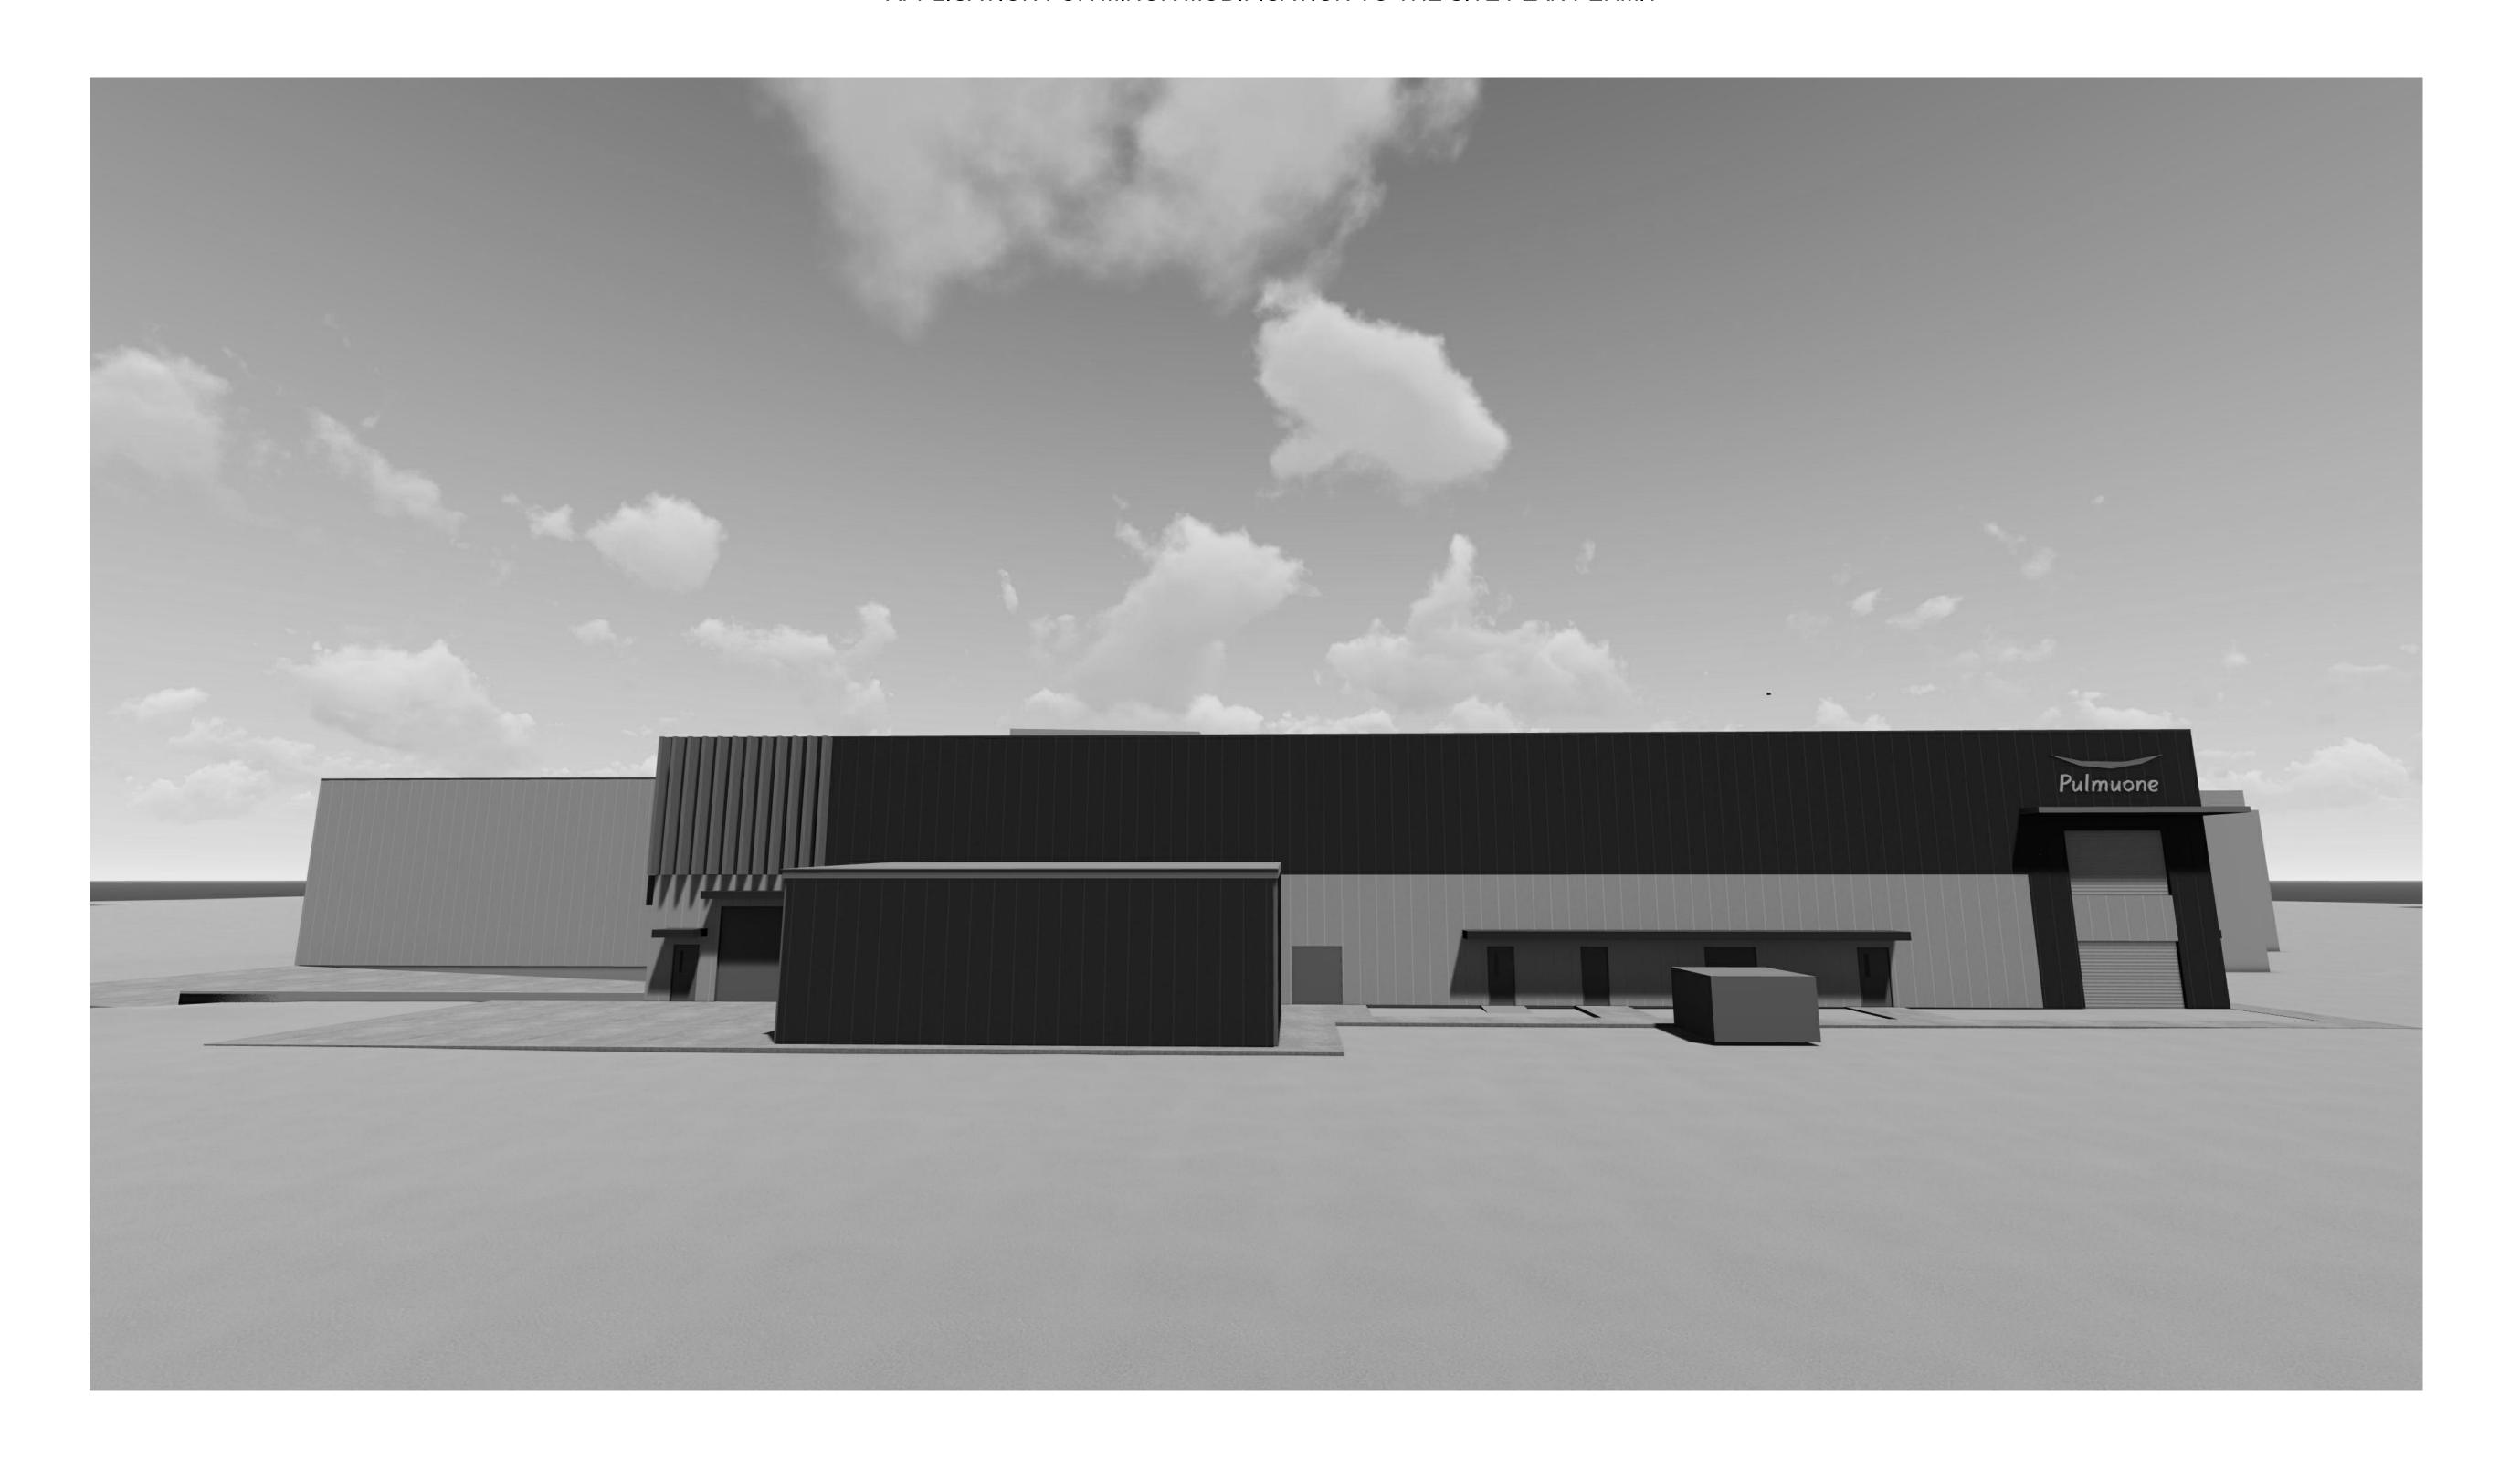


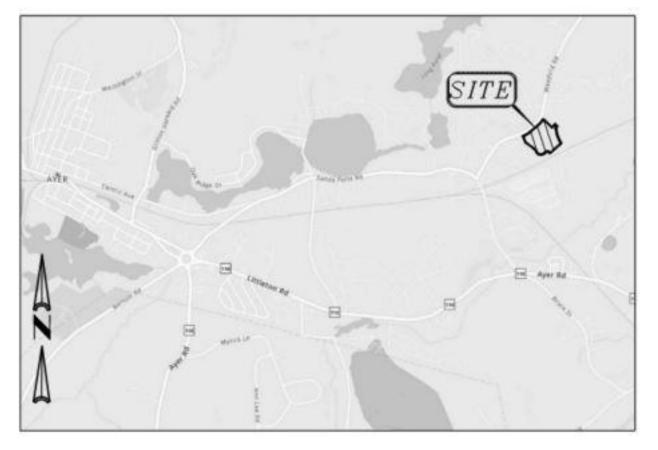

LOCATION MAP

CIVIL ENGINEER:

Kelly Engineering Group, Inc. 0 Campanelli Drive Braintree, MA 02184 Phone: (781)-843-4333

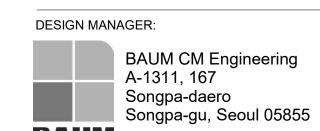

		INDEX OF DRAWINGS			
			REVIS	REVISIONS	
SHEET ID	DISCIPLINE	TITLE	REV. NO.	AM/COP NO.	PHASE 1
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1	CIVIL	COVER	A		
2	CIVIL	EXISTING CONDITION PLAN	A		
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6	CIVIL	SEWER, DRAIN & UTILITY PLAN	A		
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12	CIVIL	DETAIL SHEET 4	A		
-	ELECTRICAL	PHOTOMETRIC PLAN			



Nasoya Food Factory
Expansion and Renovation Project

CONTRACTOR:

DESIGN MANAGER:

BAUM CM Engineering a-1311, 167 Songpa-daero Songpa-gu, Seoul 05855

DESIGNER:



SUBCONTRACTOR:

NOTES:

ISSUE RECORD:

	D	PICK & PACK PERMIT	08 APF
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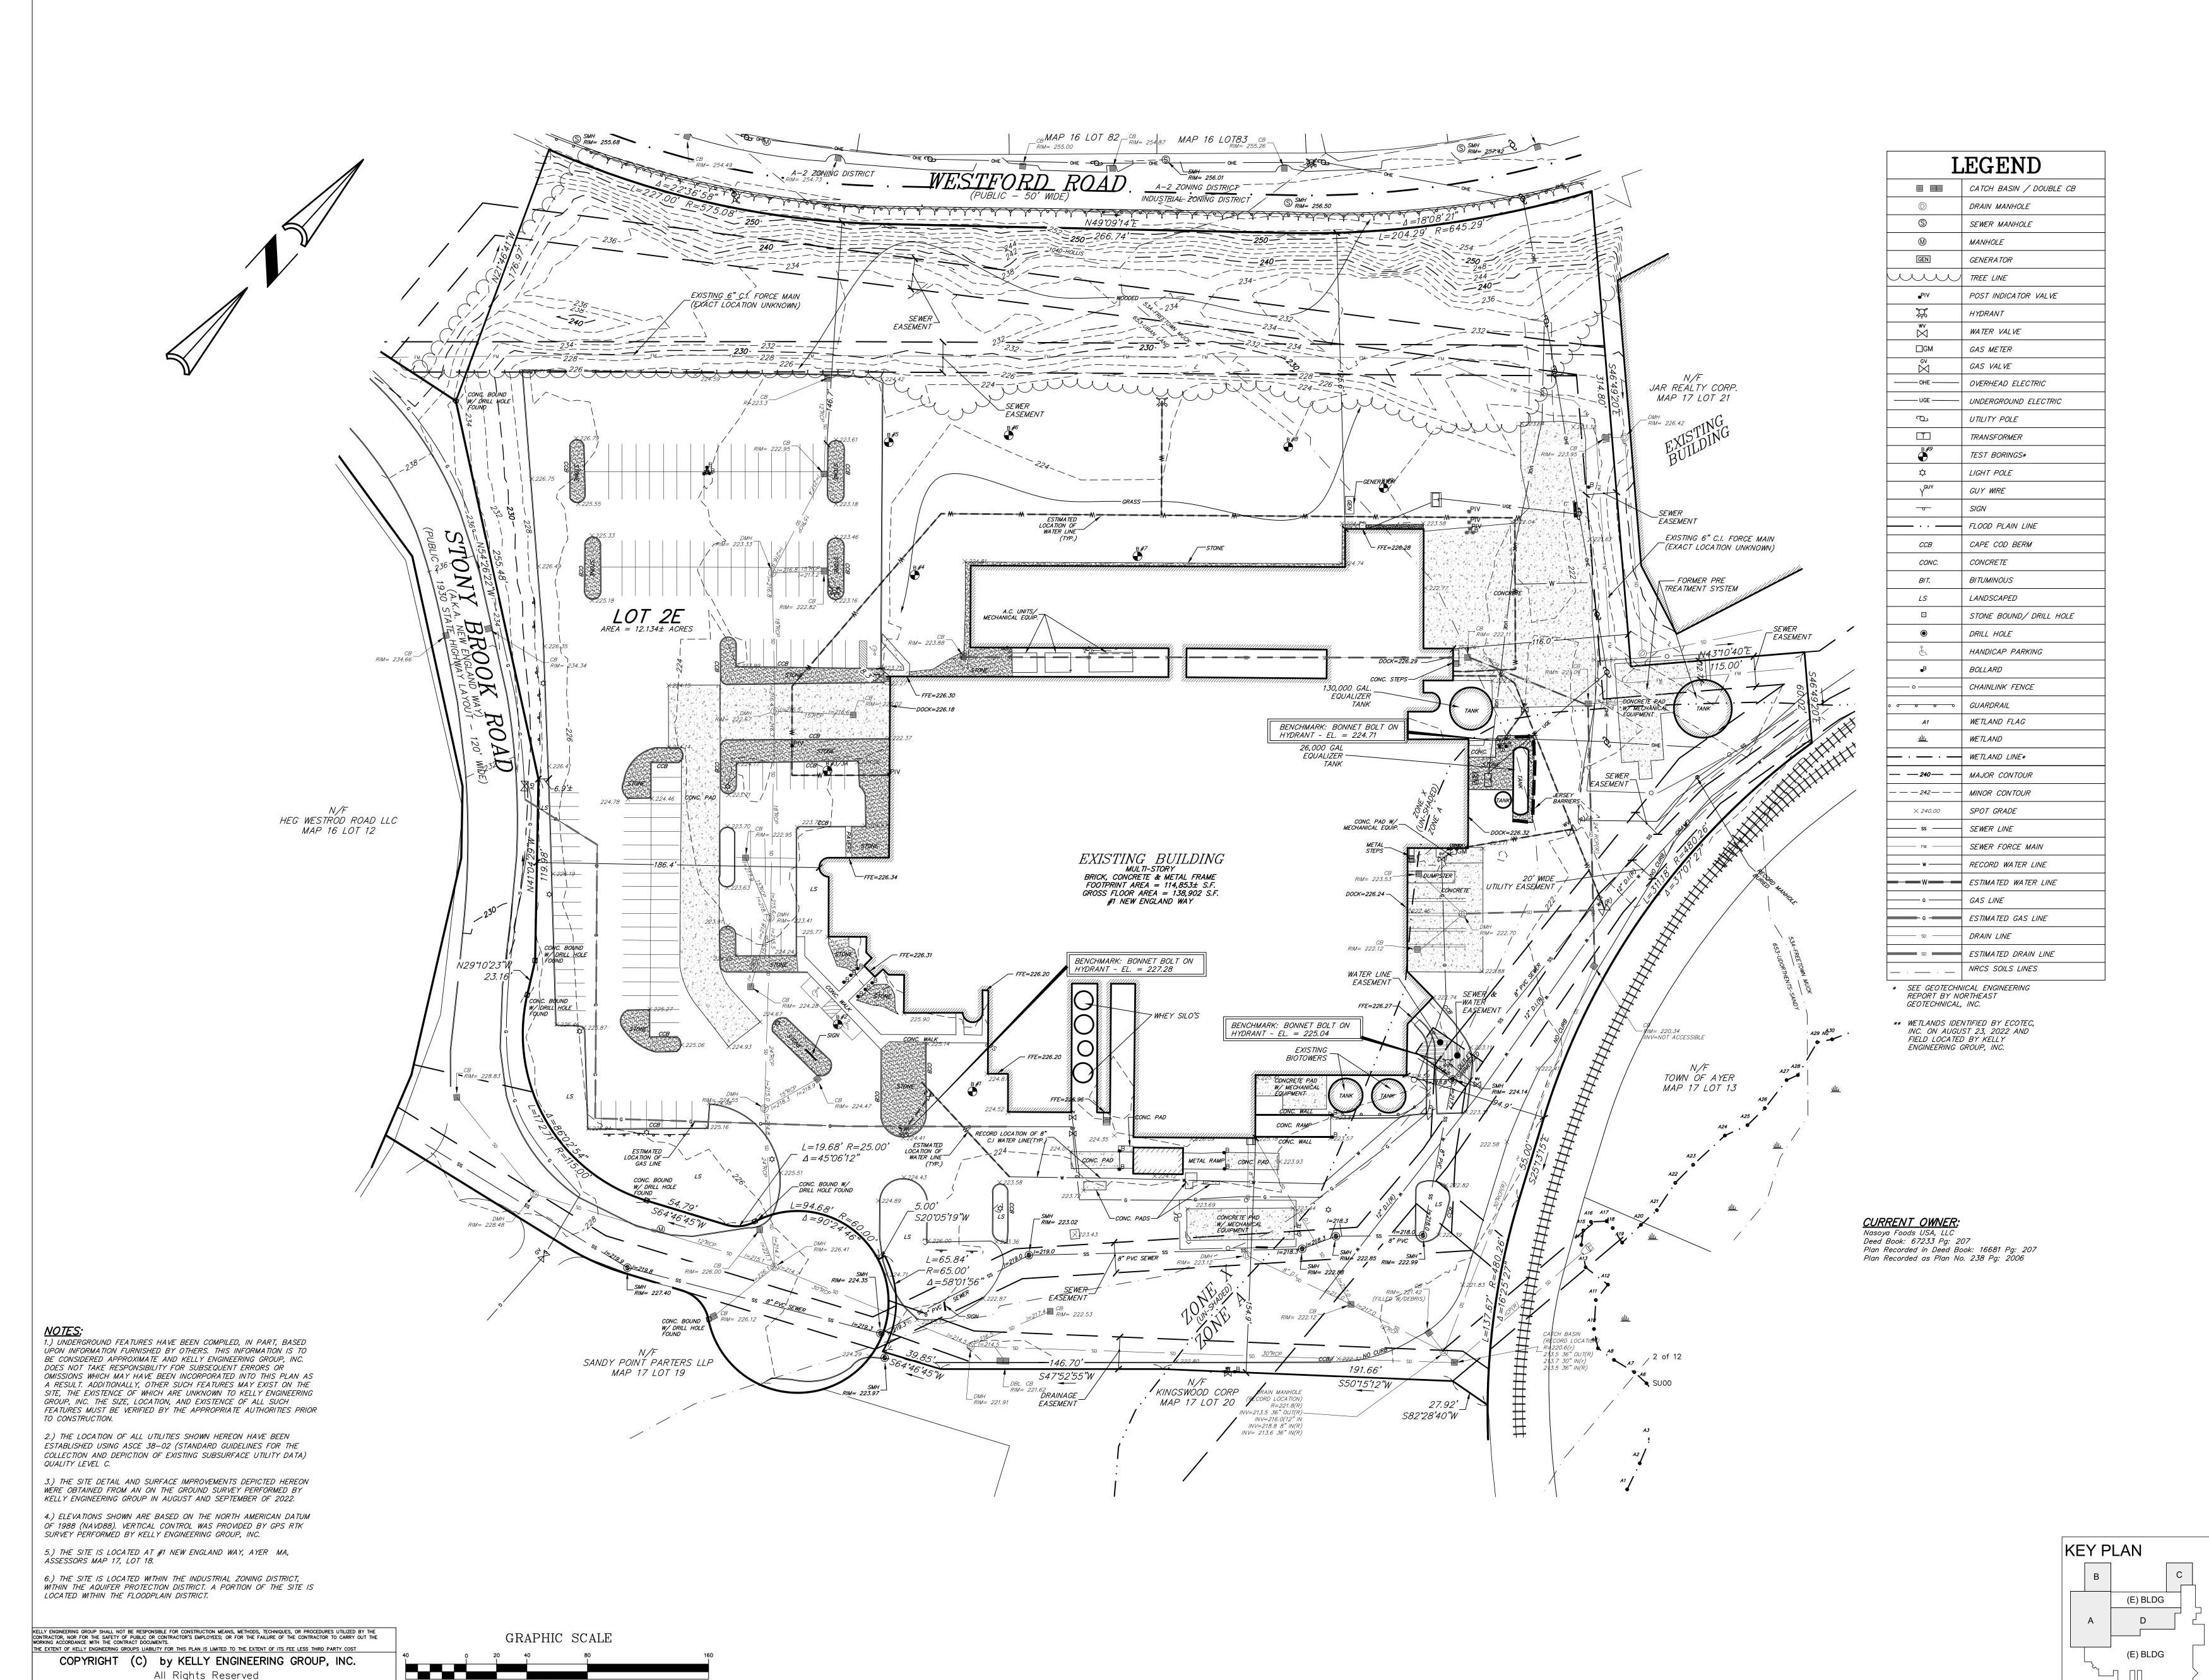
VICTORIA
HOWLAND
CIVIL 40
No. 56312

D. ANTHOLZ

08 APRIL 2024

FACTORY EXPANSION AND RENOVATION SHEET INDEX

SHEET NUMBER:



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1 inch = 40



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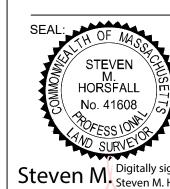


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	В	CORRECTED SD	04 MAR 24
	Α	SCHEMATIC	02/07/24
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Steven M. Digitally signed by Steven M. Horsfall D. ANTHOLZ Horsfall Date: 2024.04.10 DATE 17:43:21 -04'00'


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FACTORY EXPANSION AND RENOVATION 7

ONE NEW ENGLAND WAY AYER, MA

SHEET NUMBER:

**EXISTING CONDITIONS** 

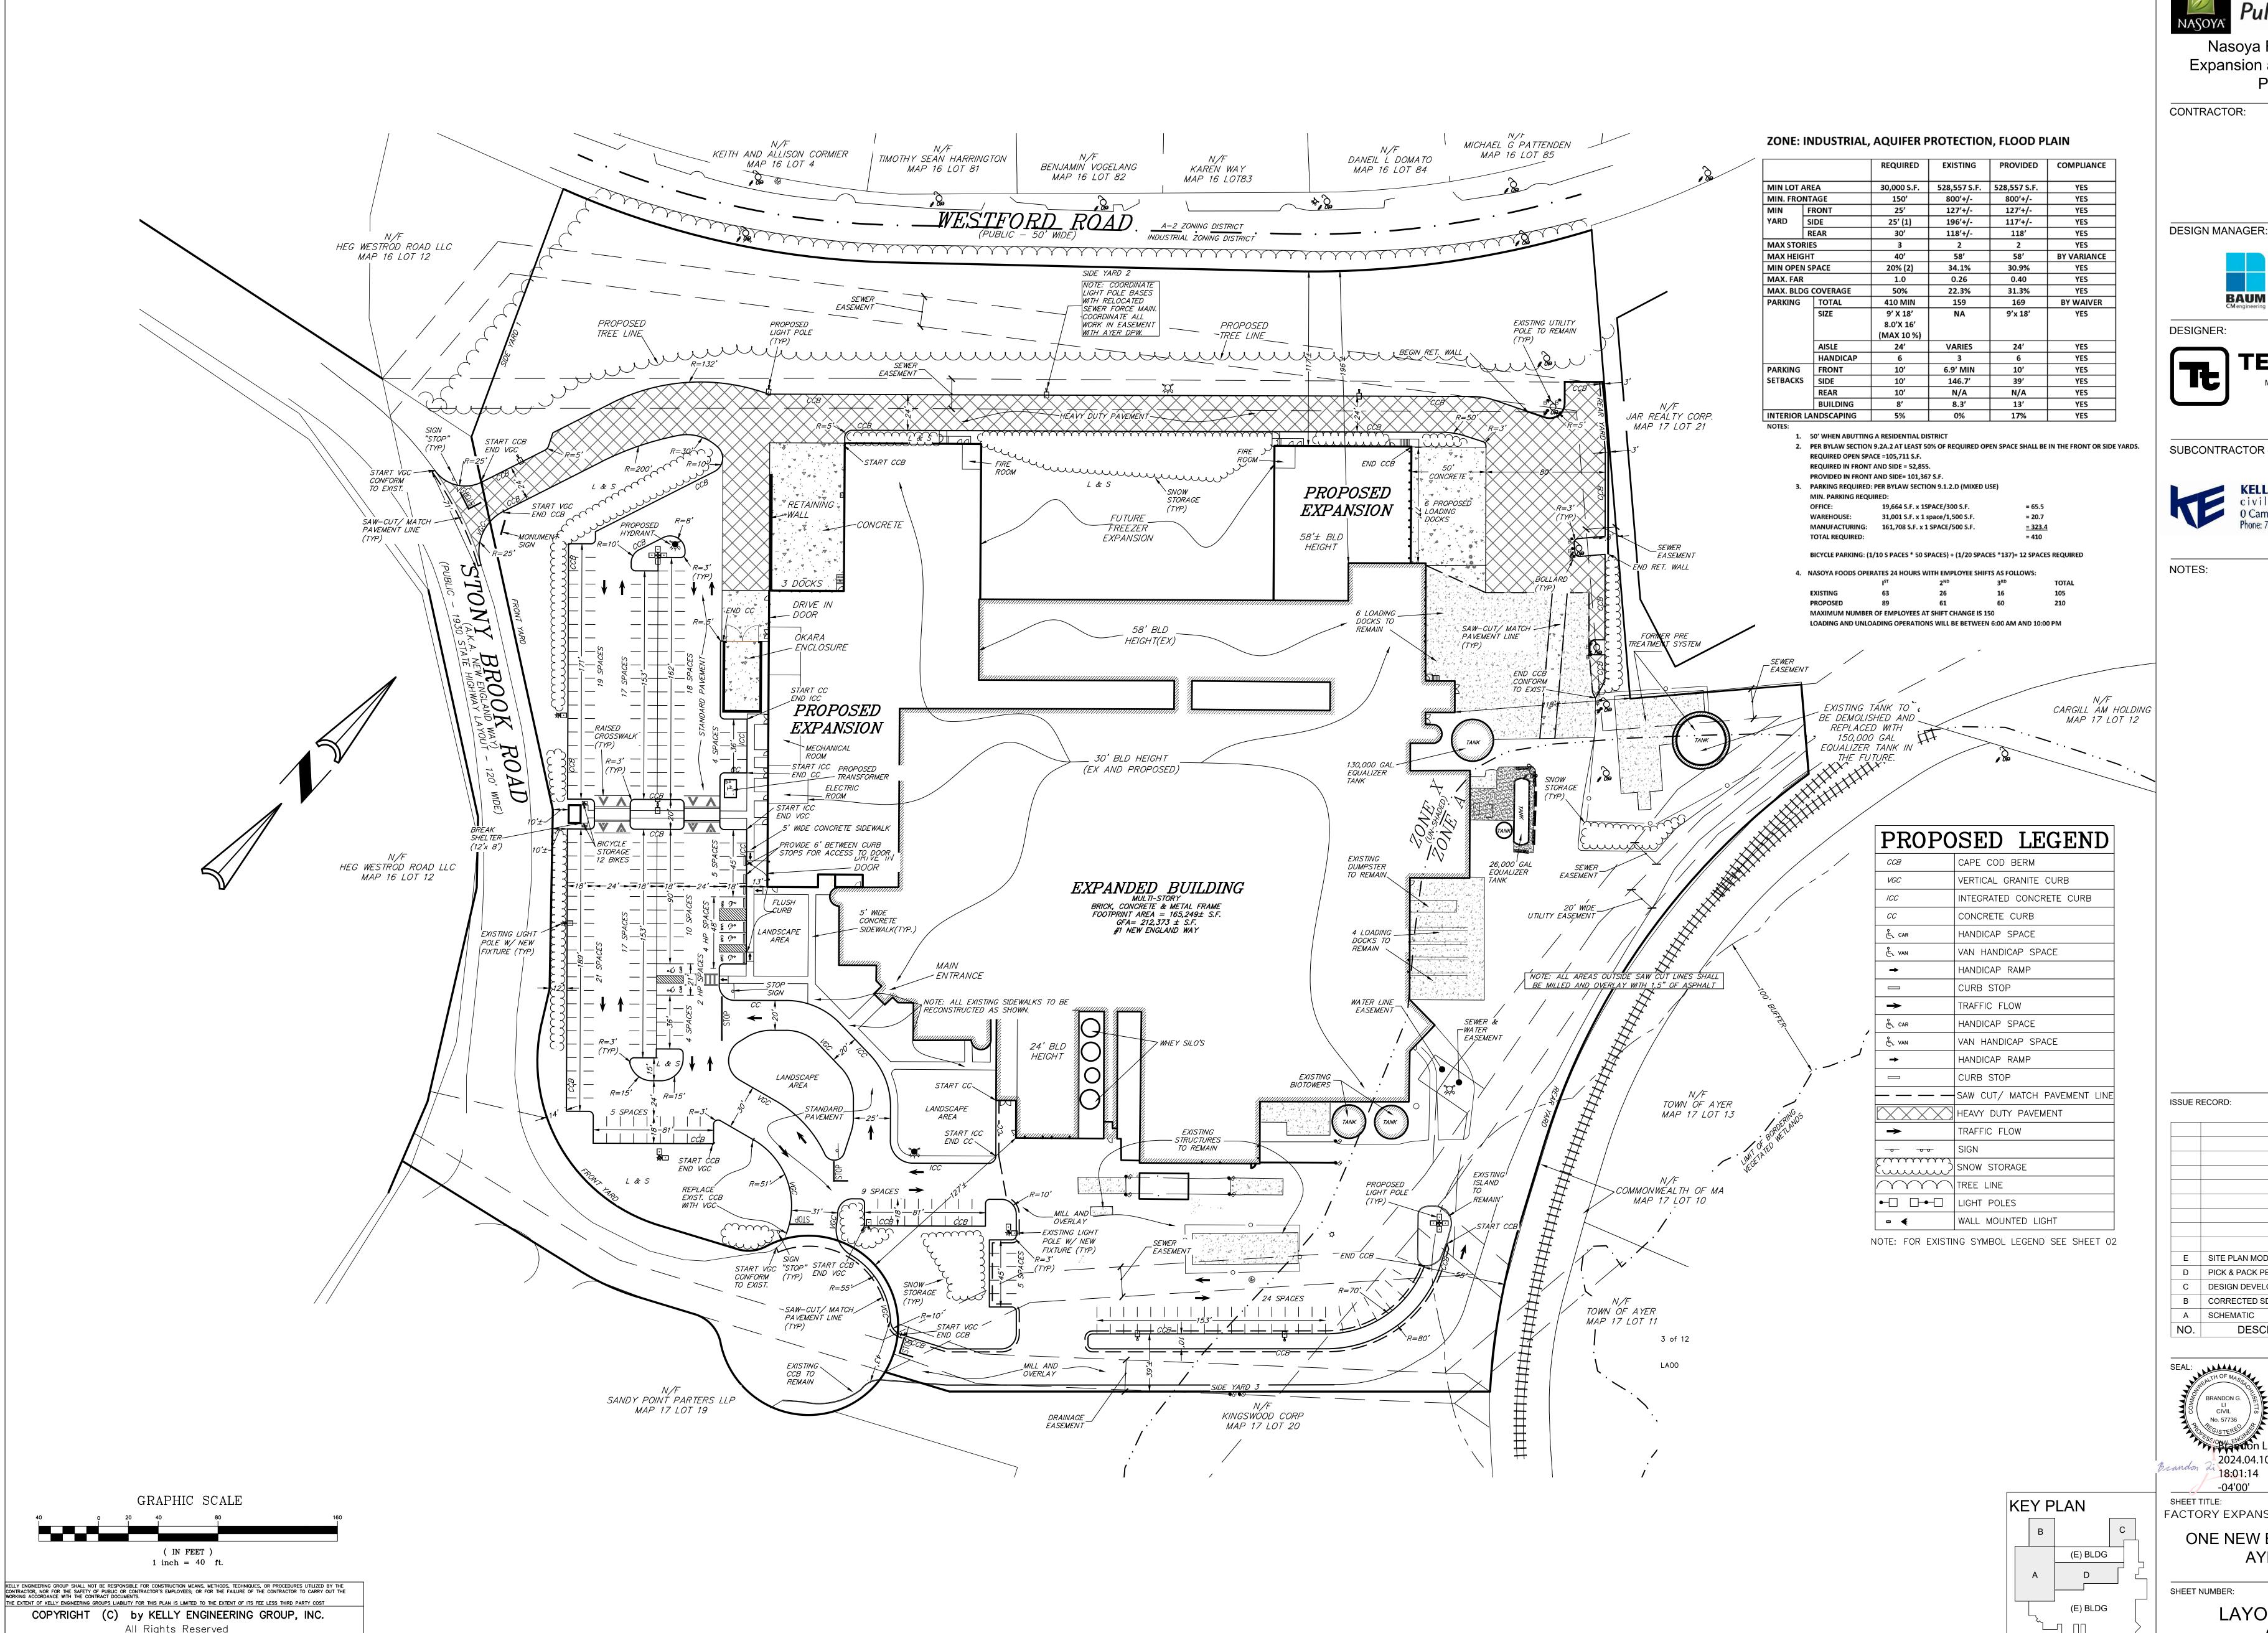

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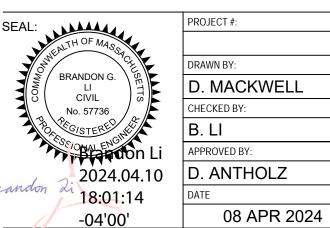


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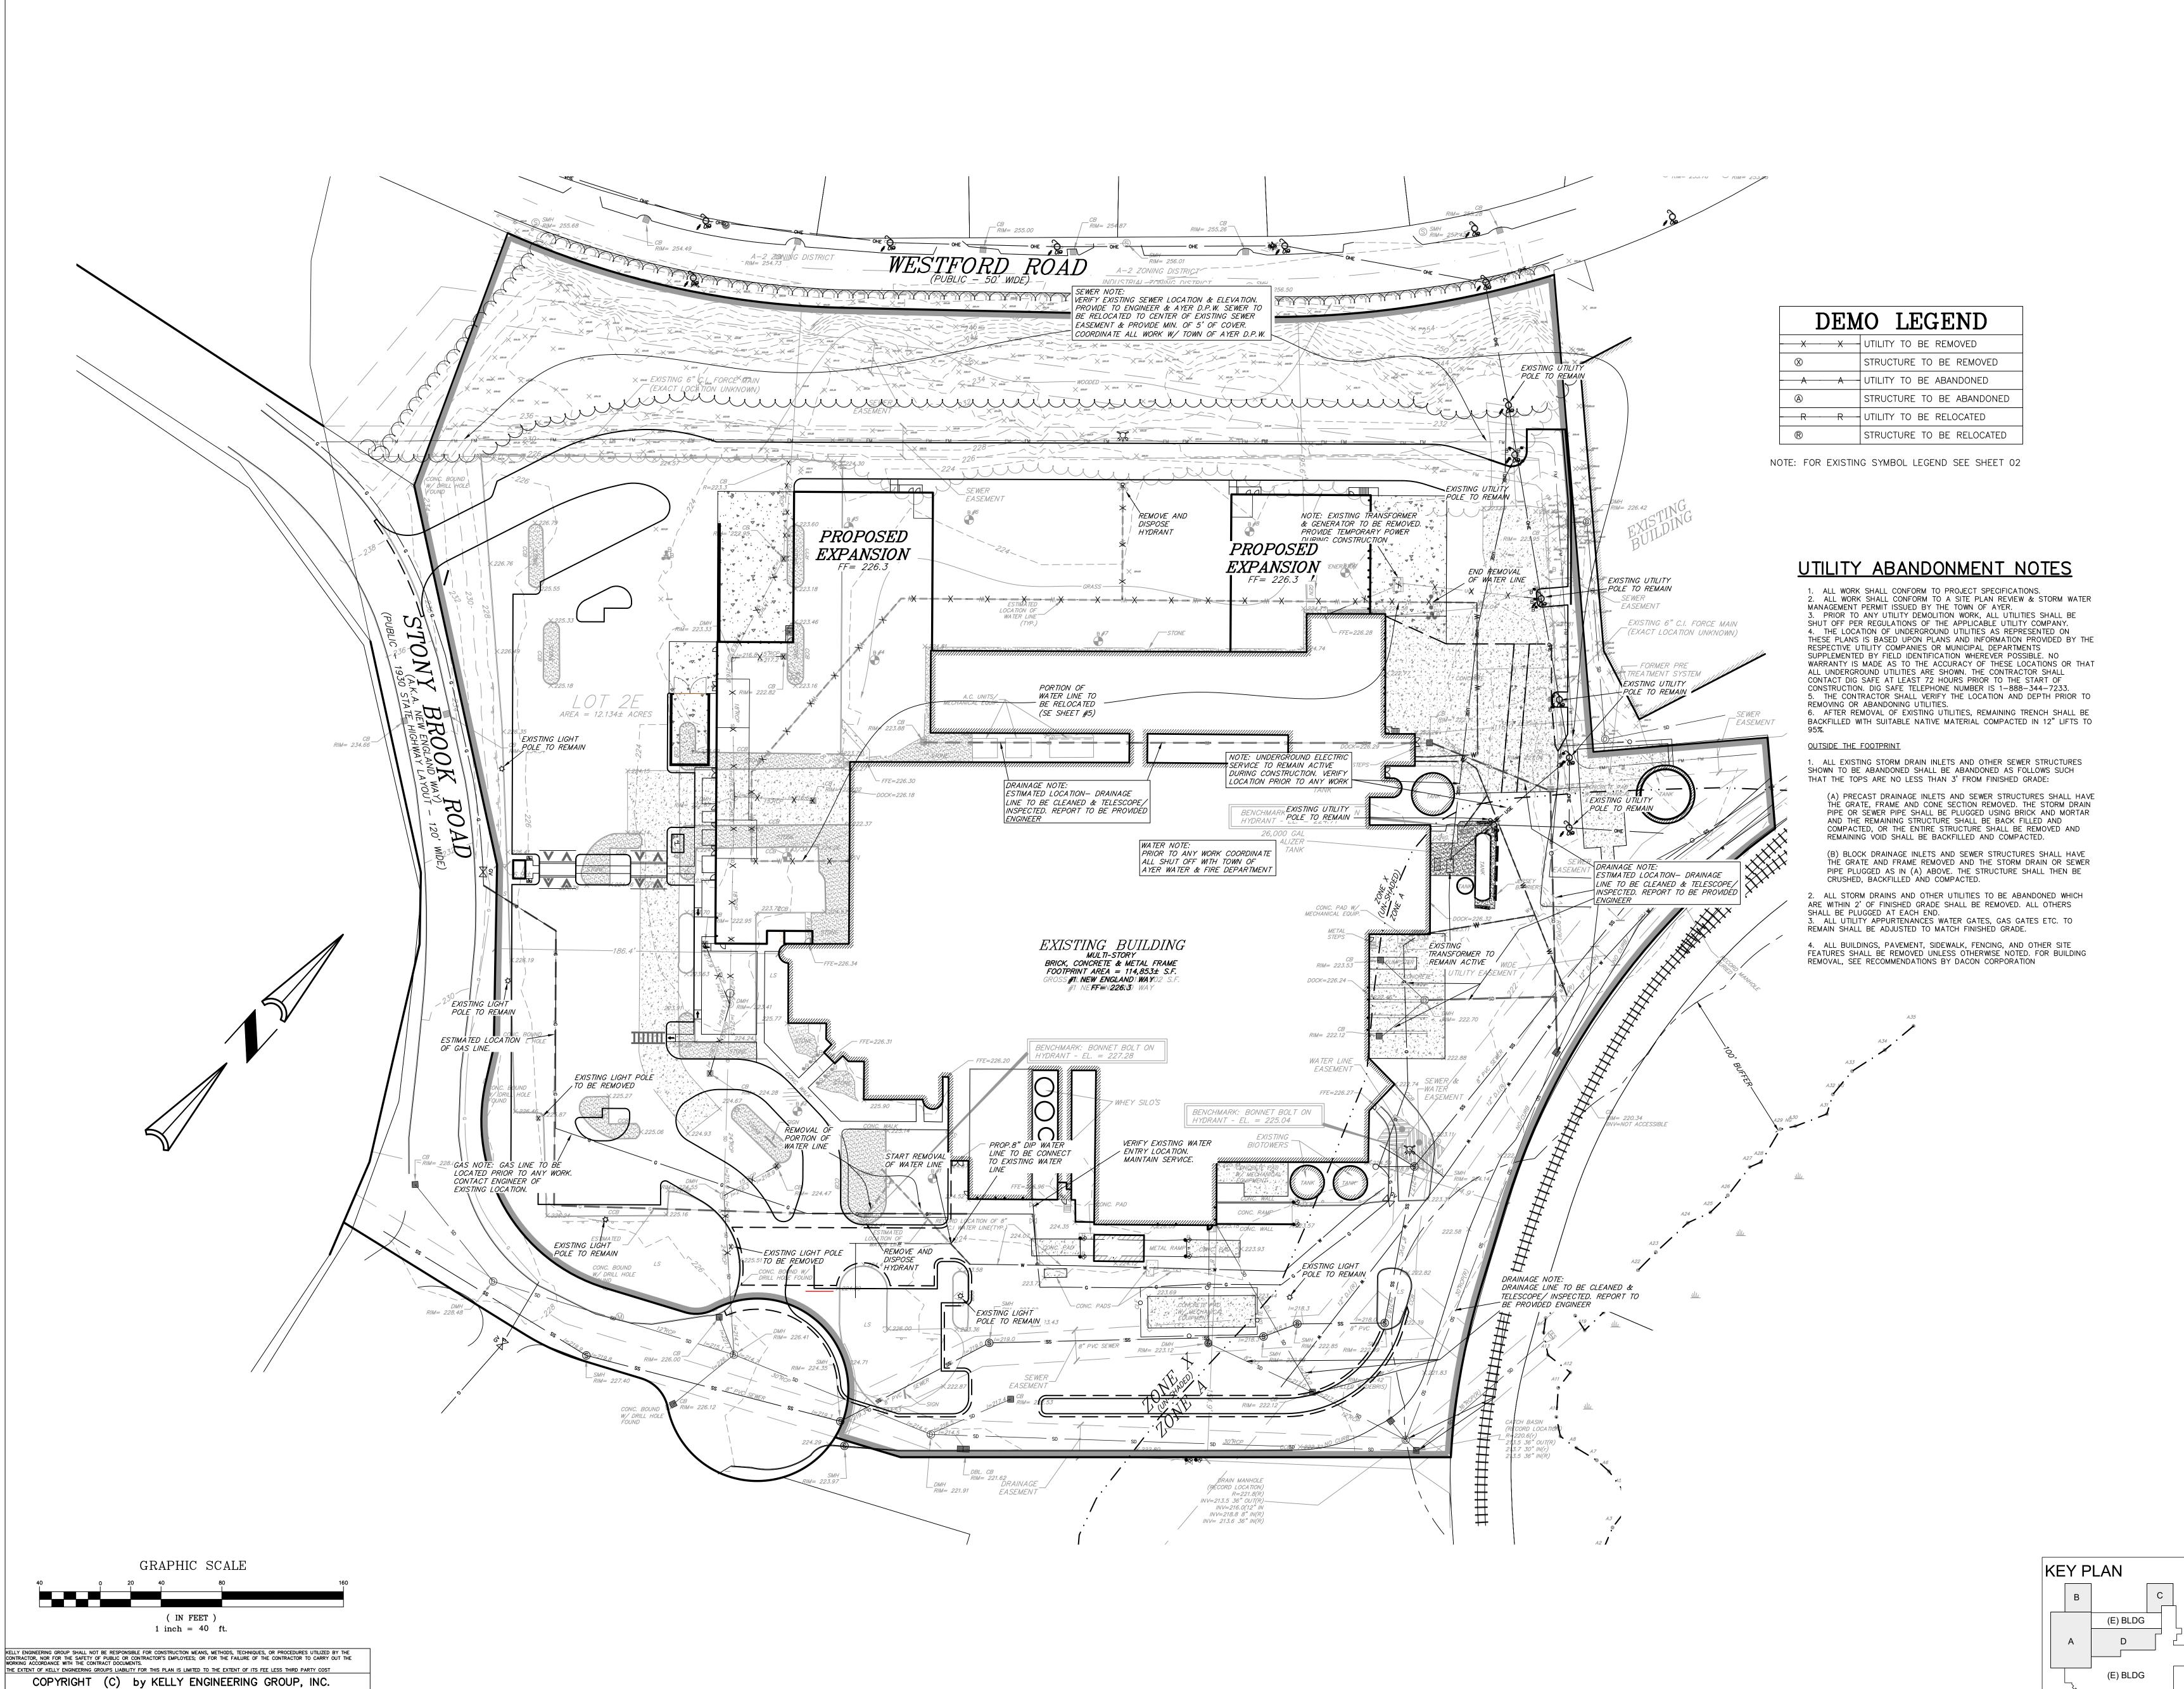
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LAYOUT PLAN C-3



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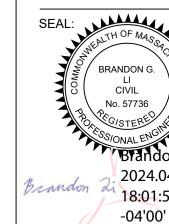


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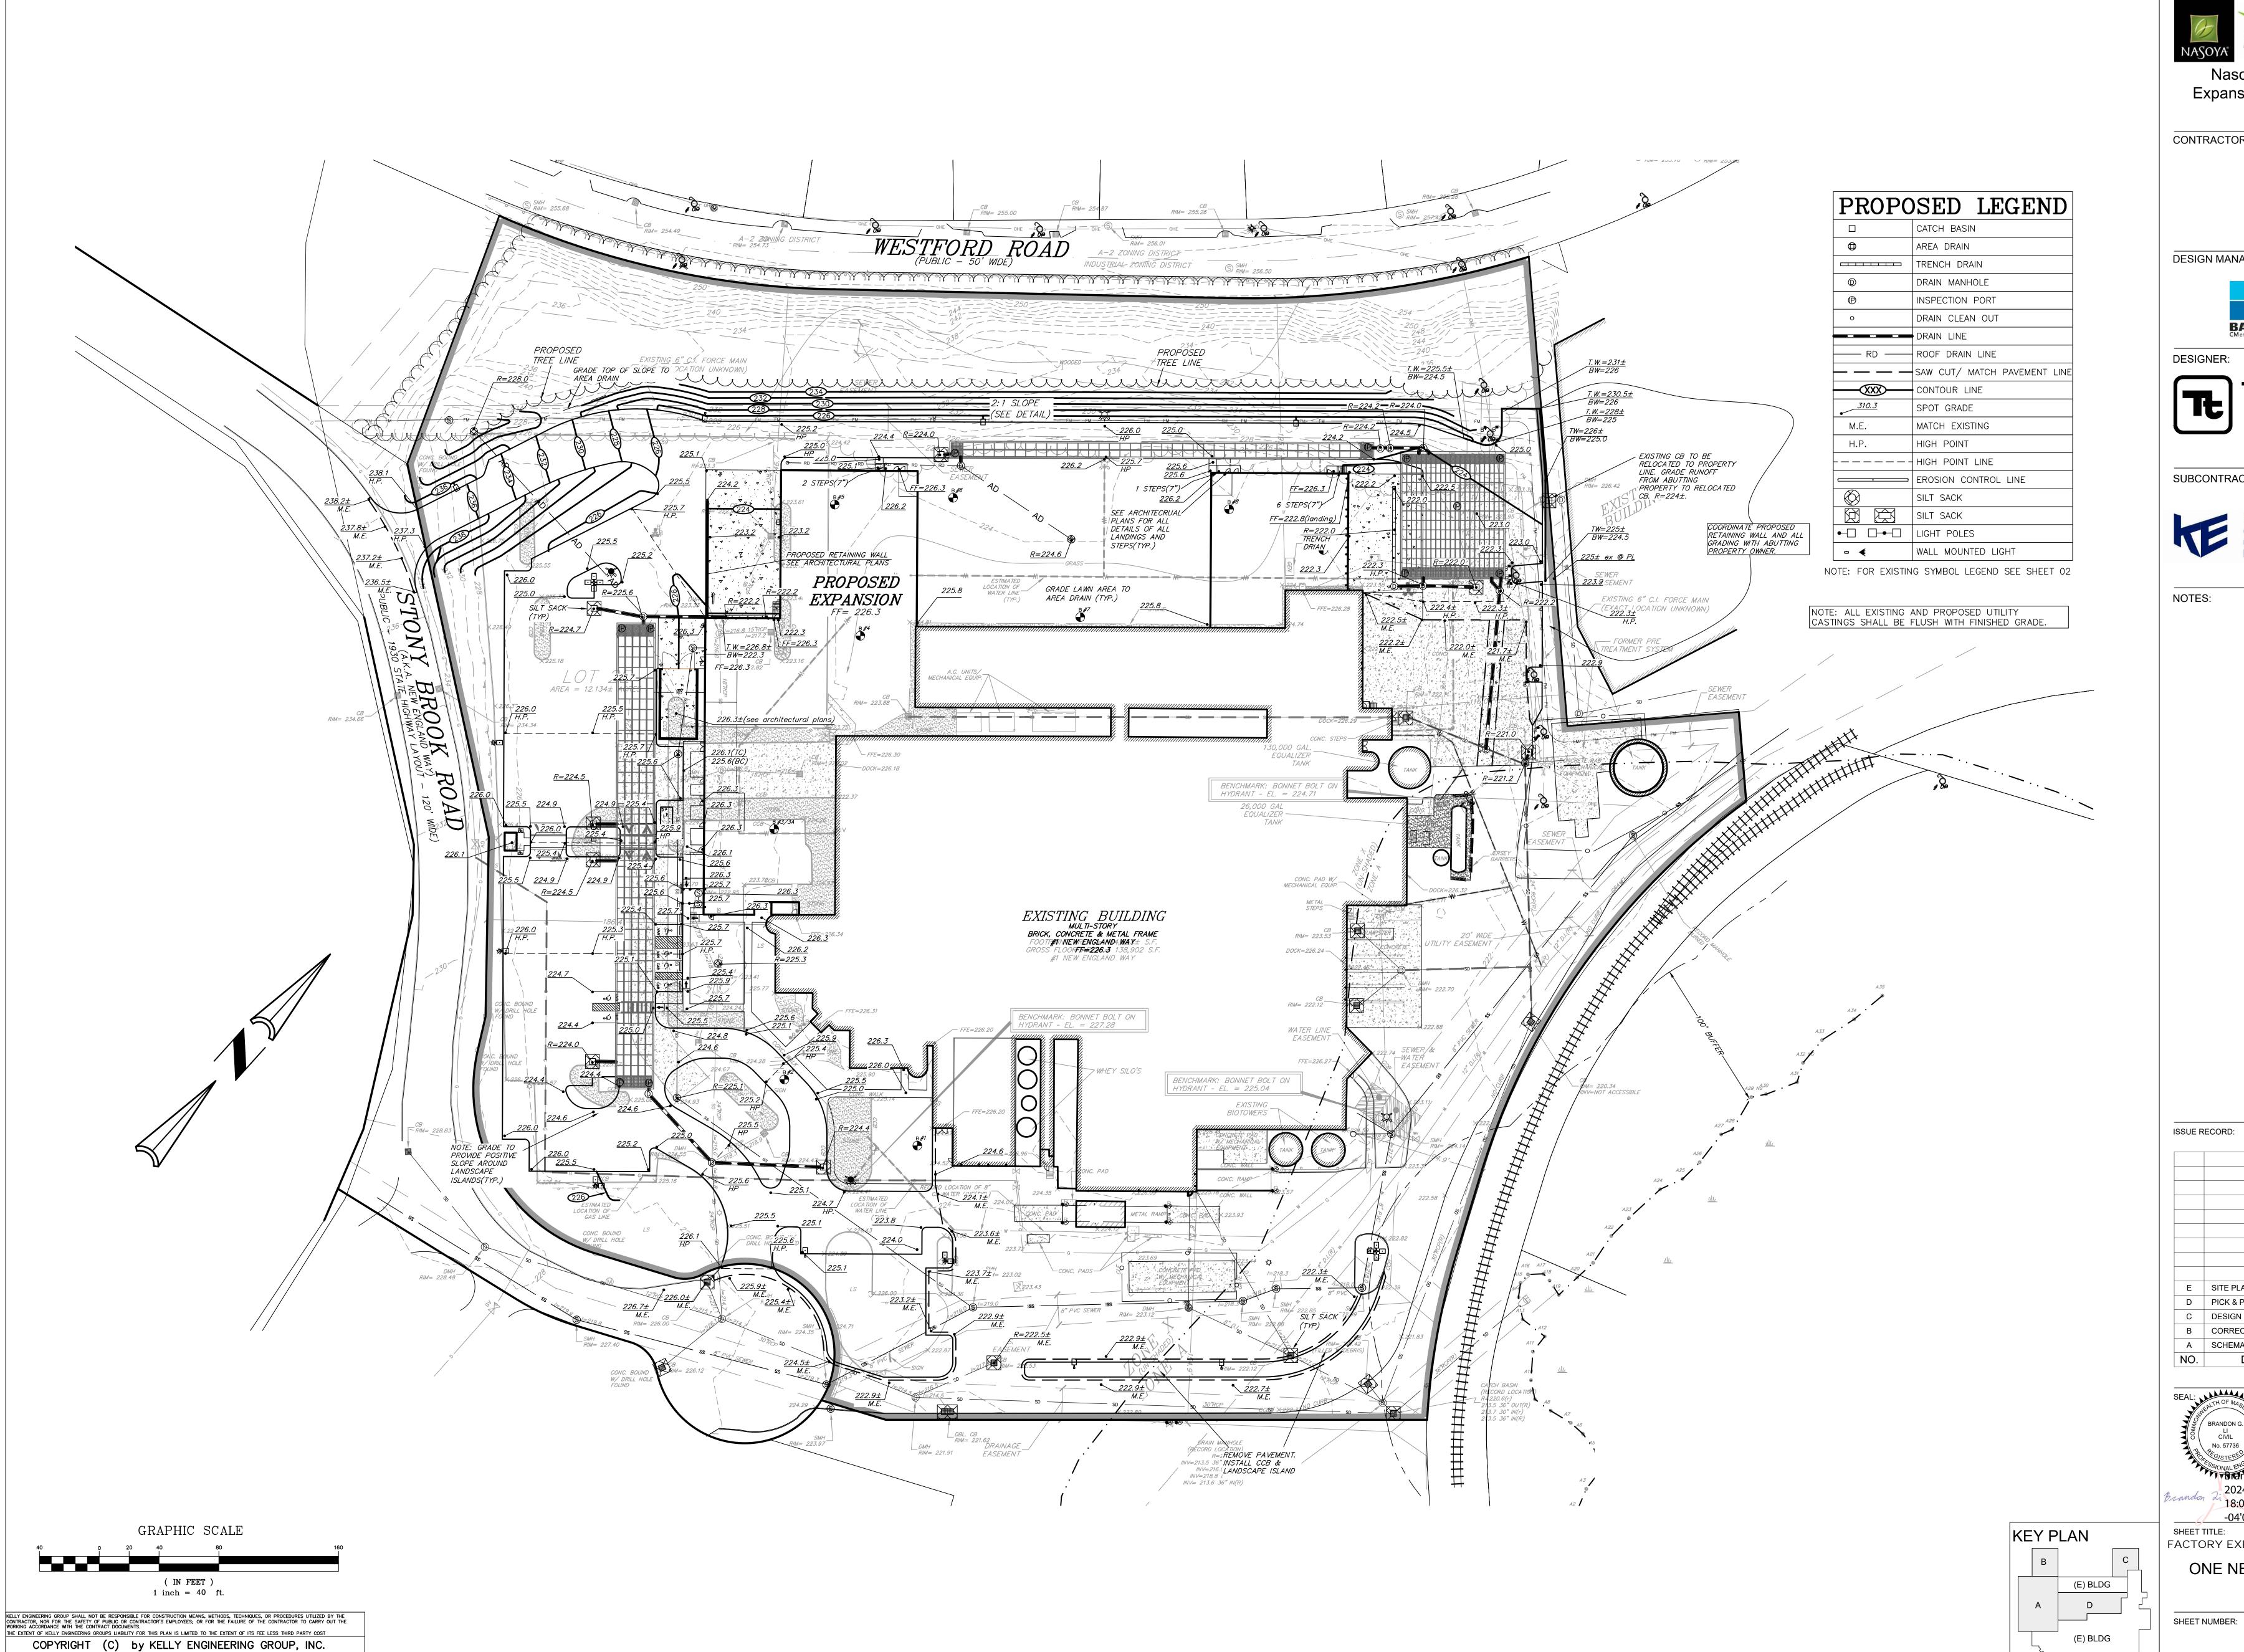
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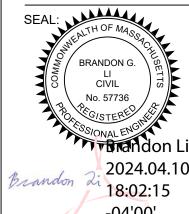
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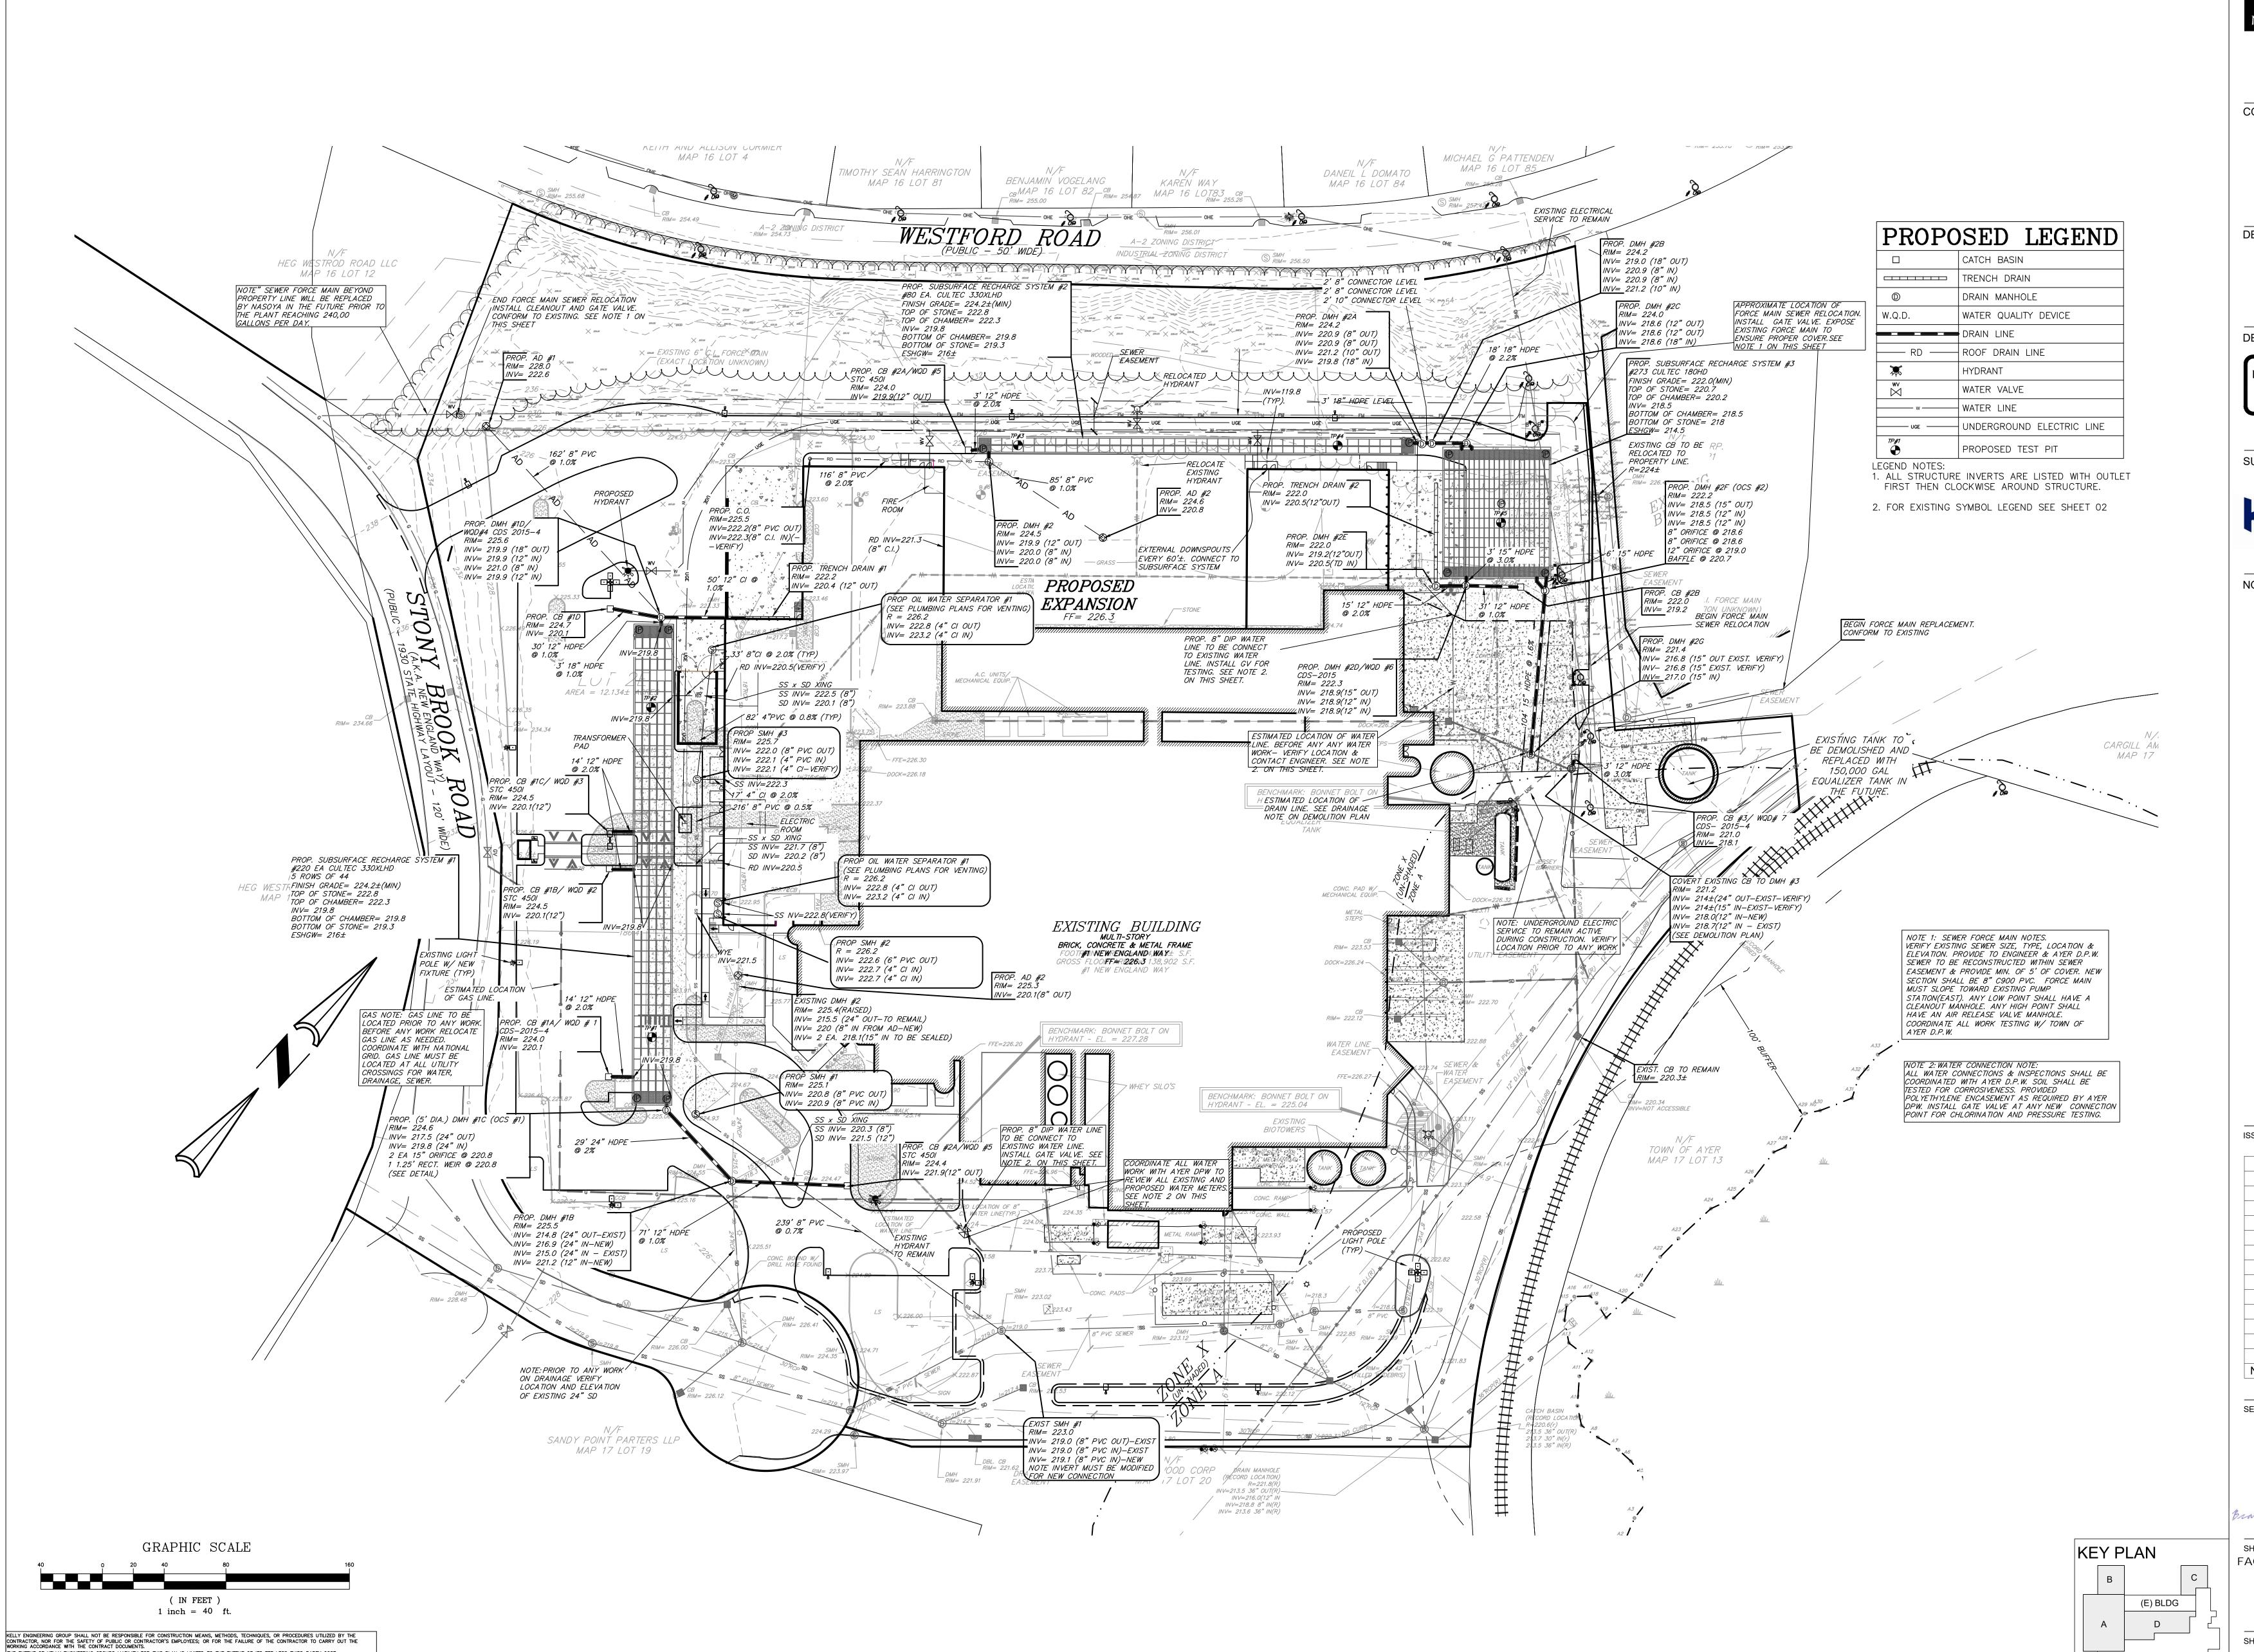
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Nasoya Food Factory
Expansion and Renovation
Project

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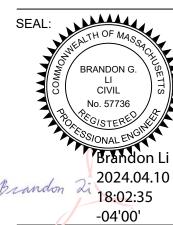


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D. MACKWELL

CHECKED BY:

B. LI

APPROVED BY:

D. ANTHOLZ

DATE

08 APR 2024

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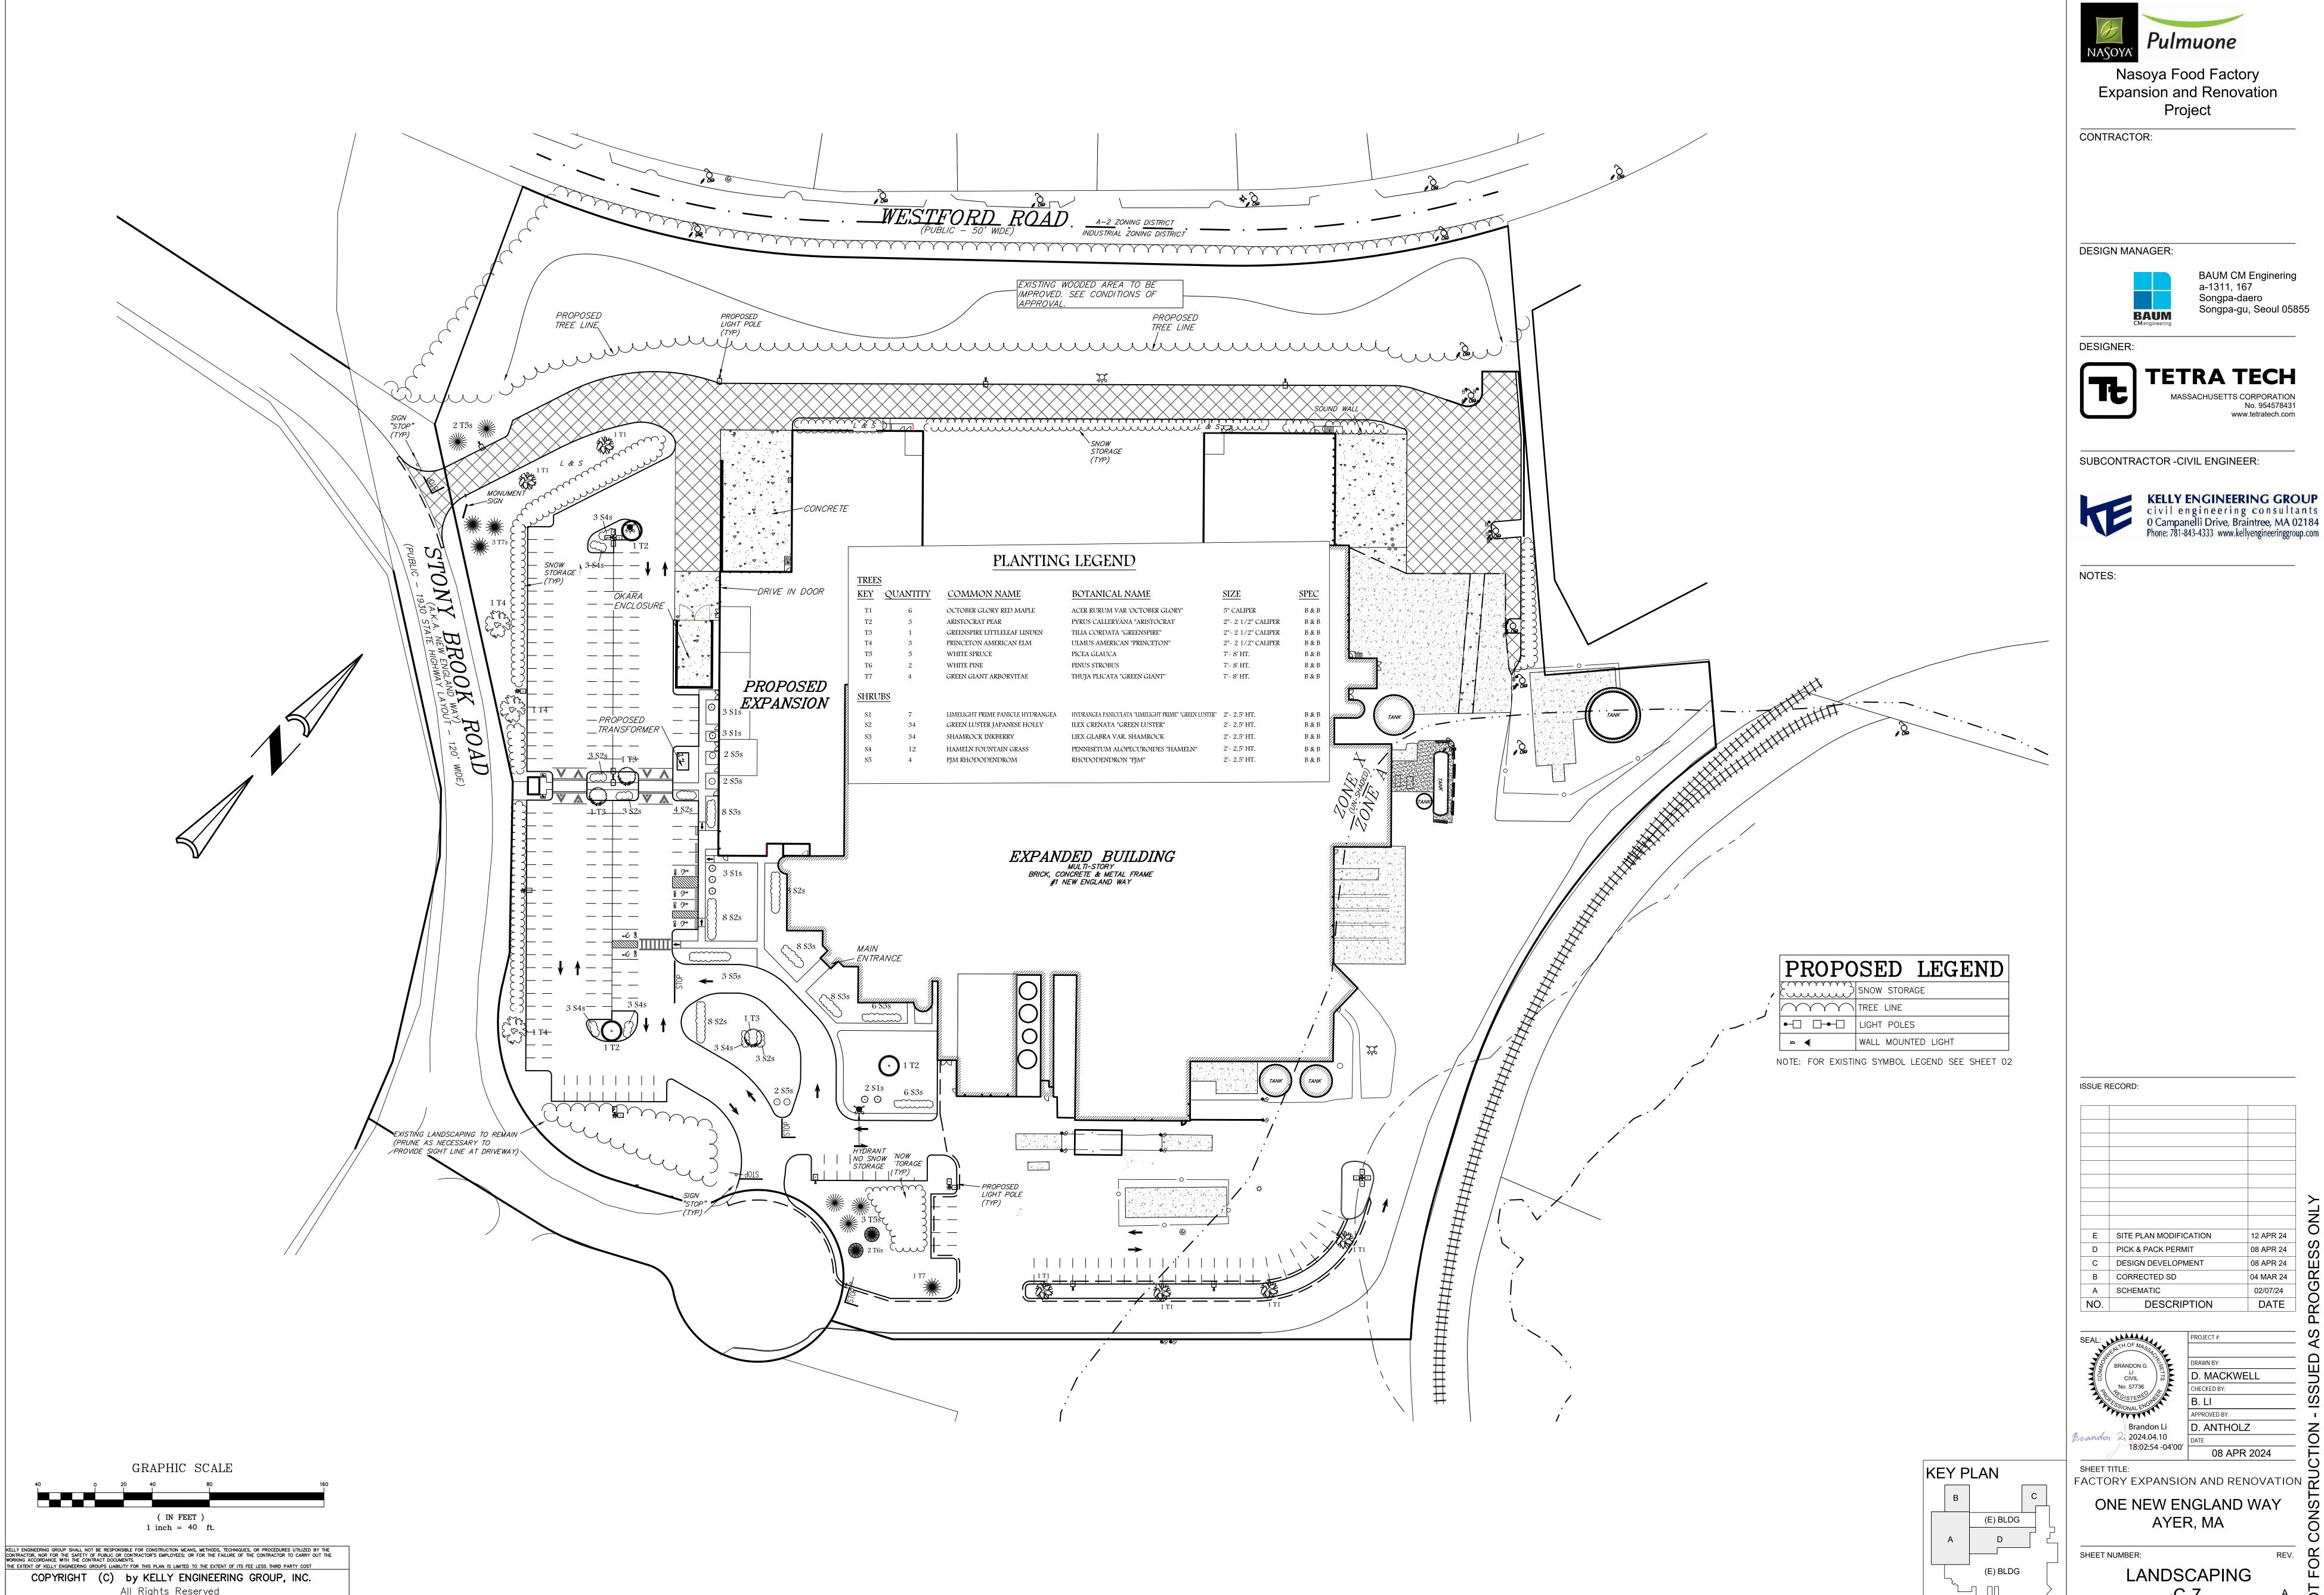
FACTORY EXPANSION AND RENOVATION

ONE NEW ENGLAND WAY AYER, MA

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SEWER, DRAIN & UTILITY



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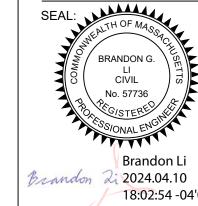


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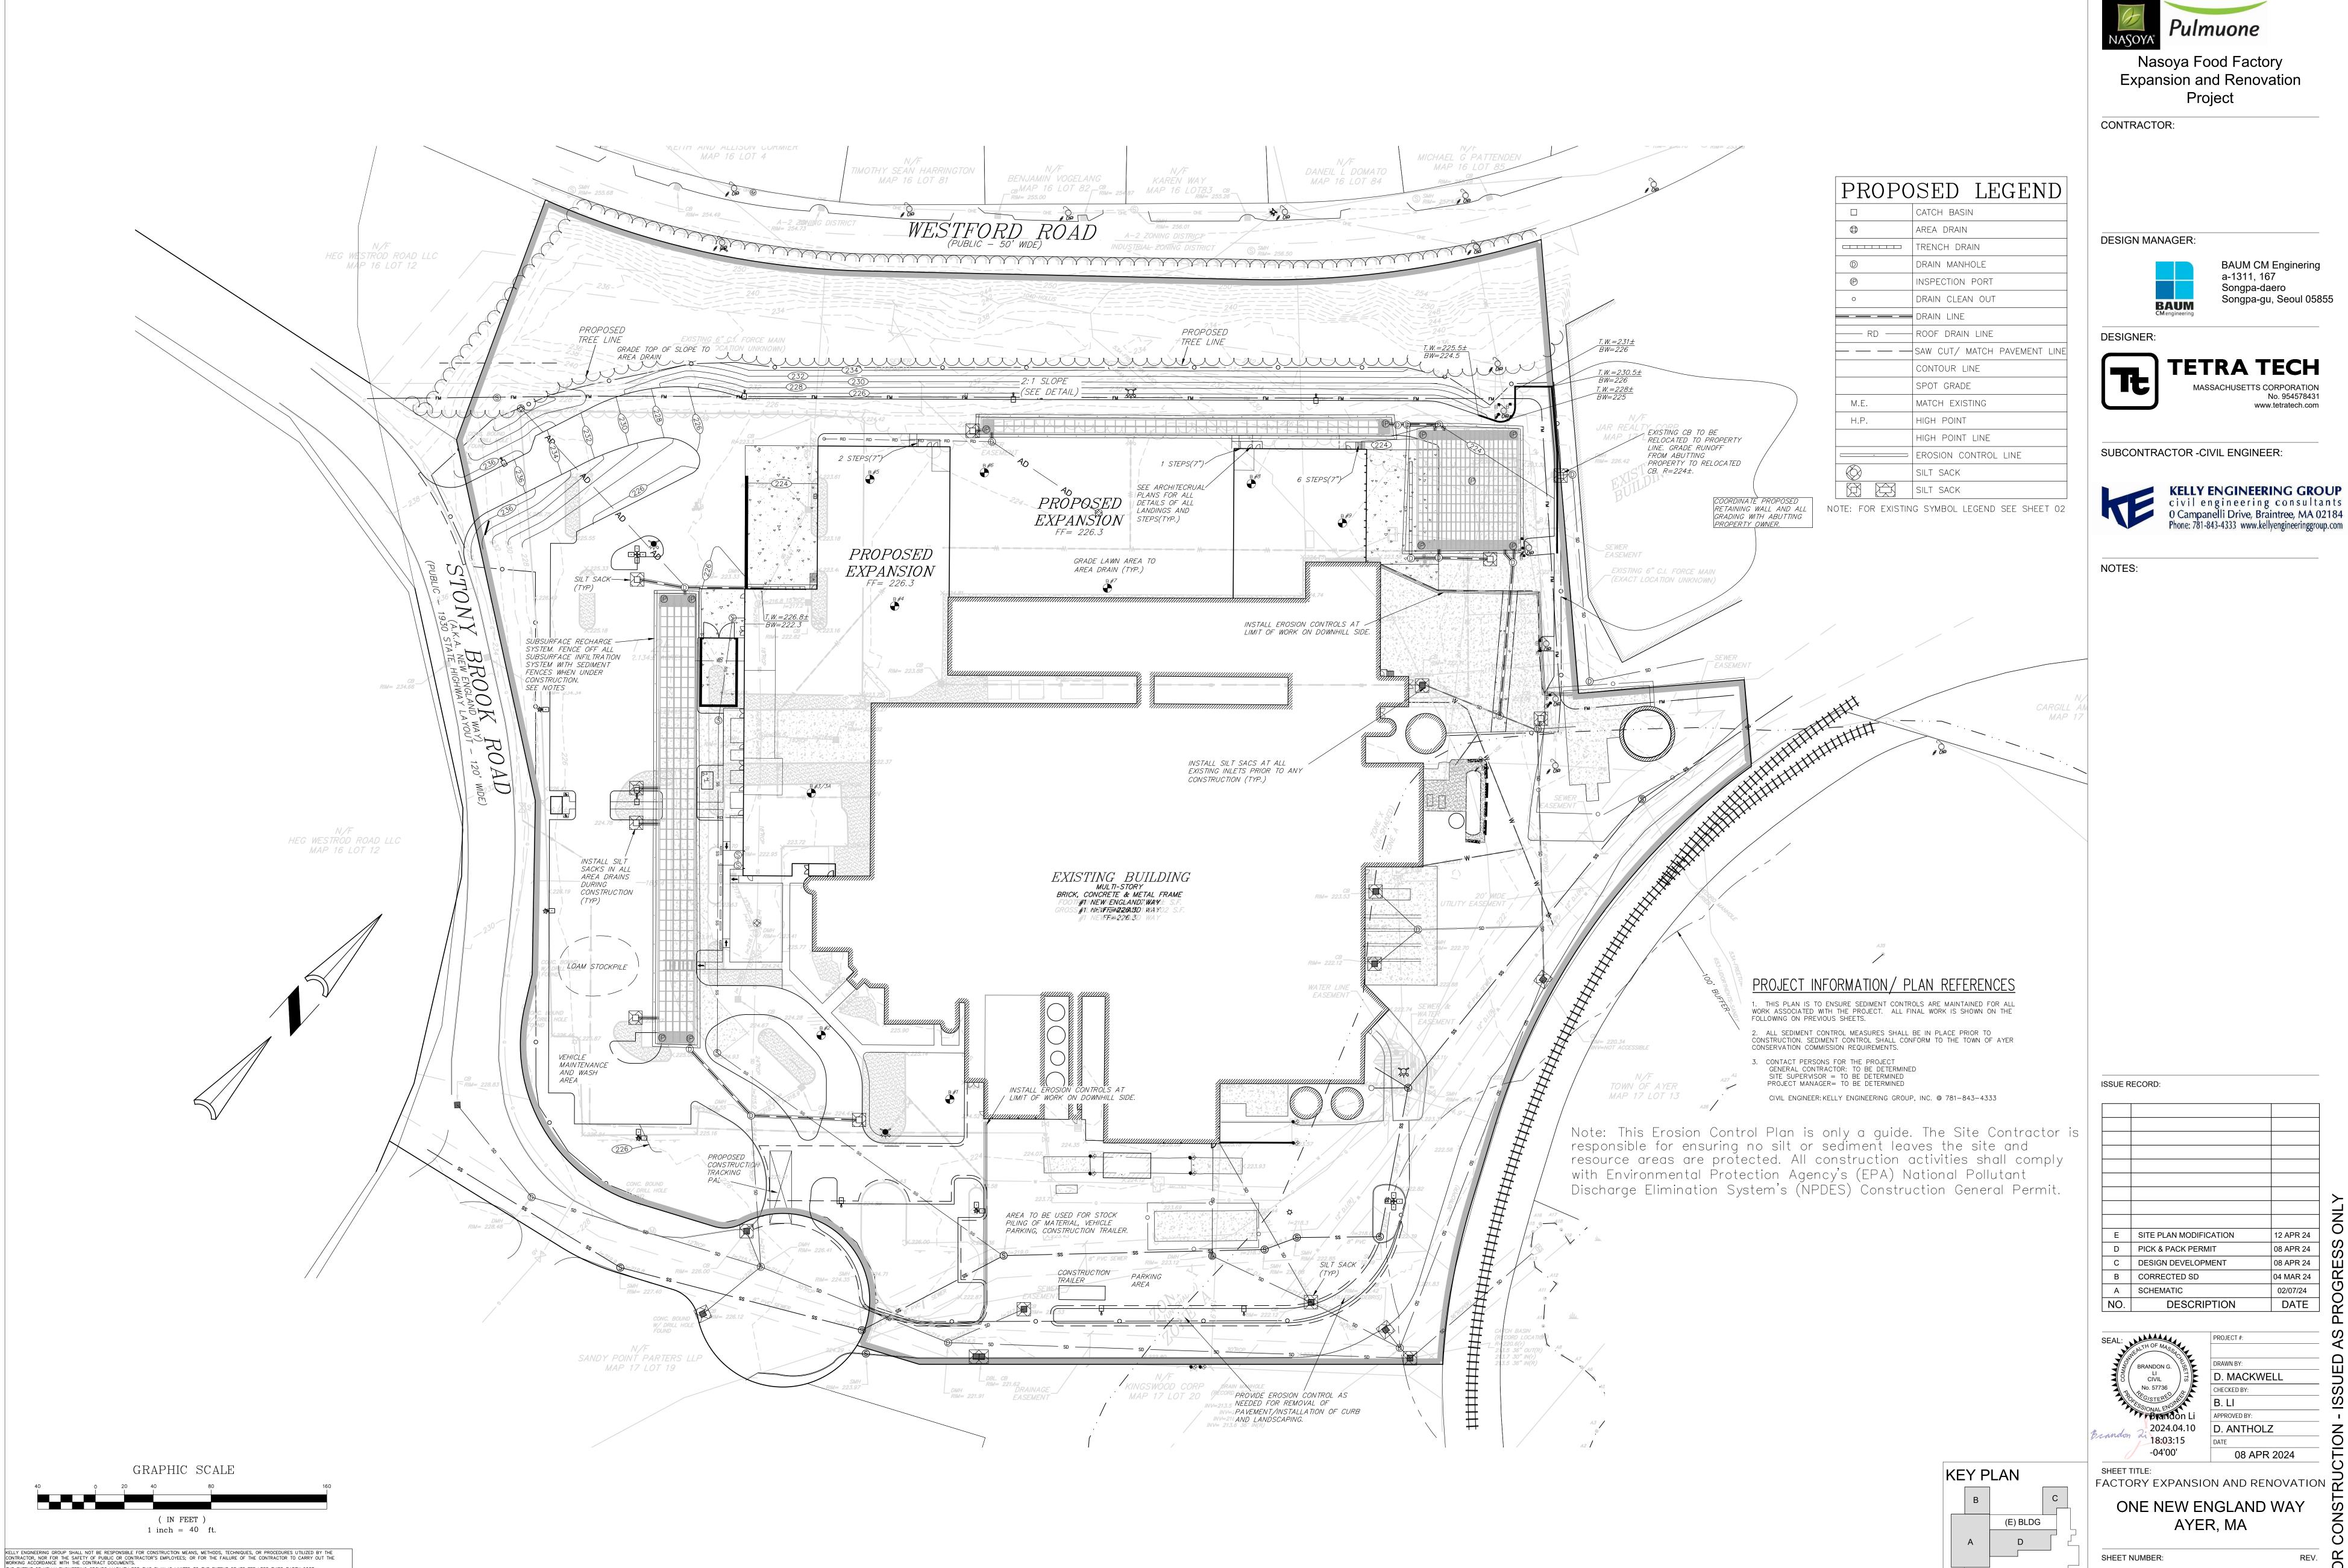


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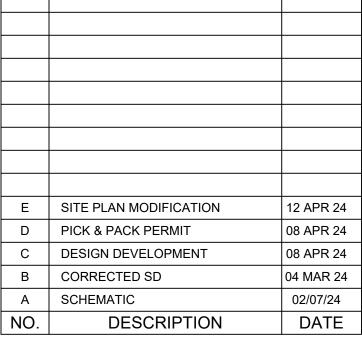



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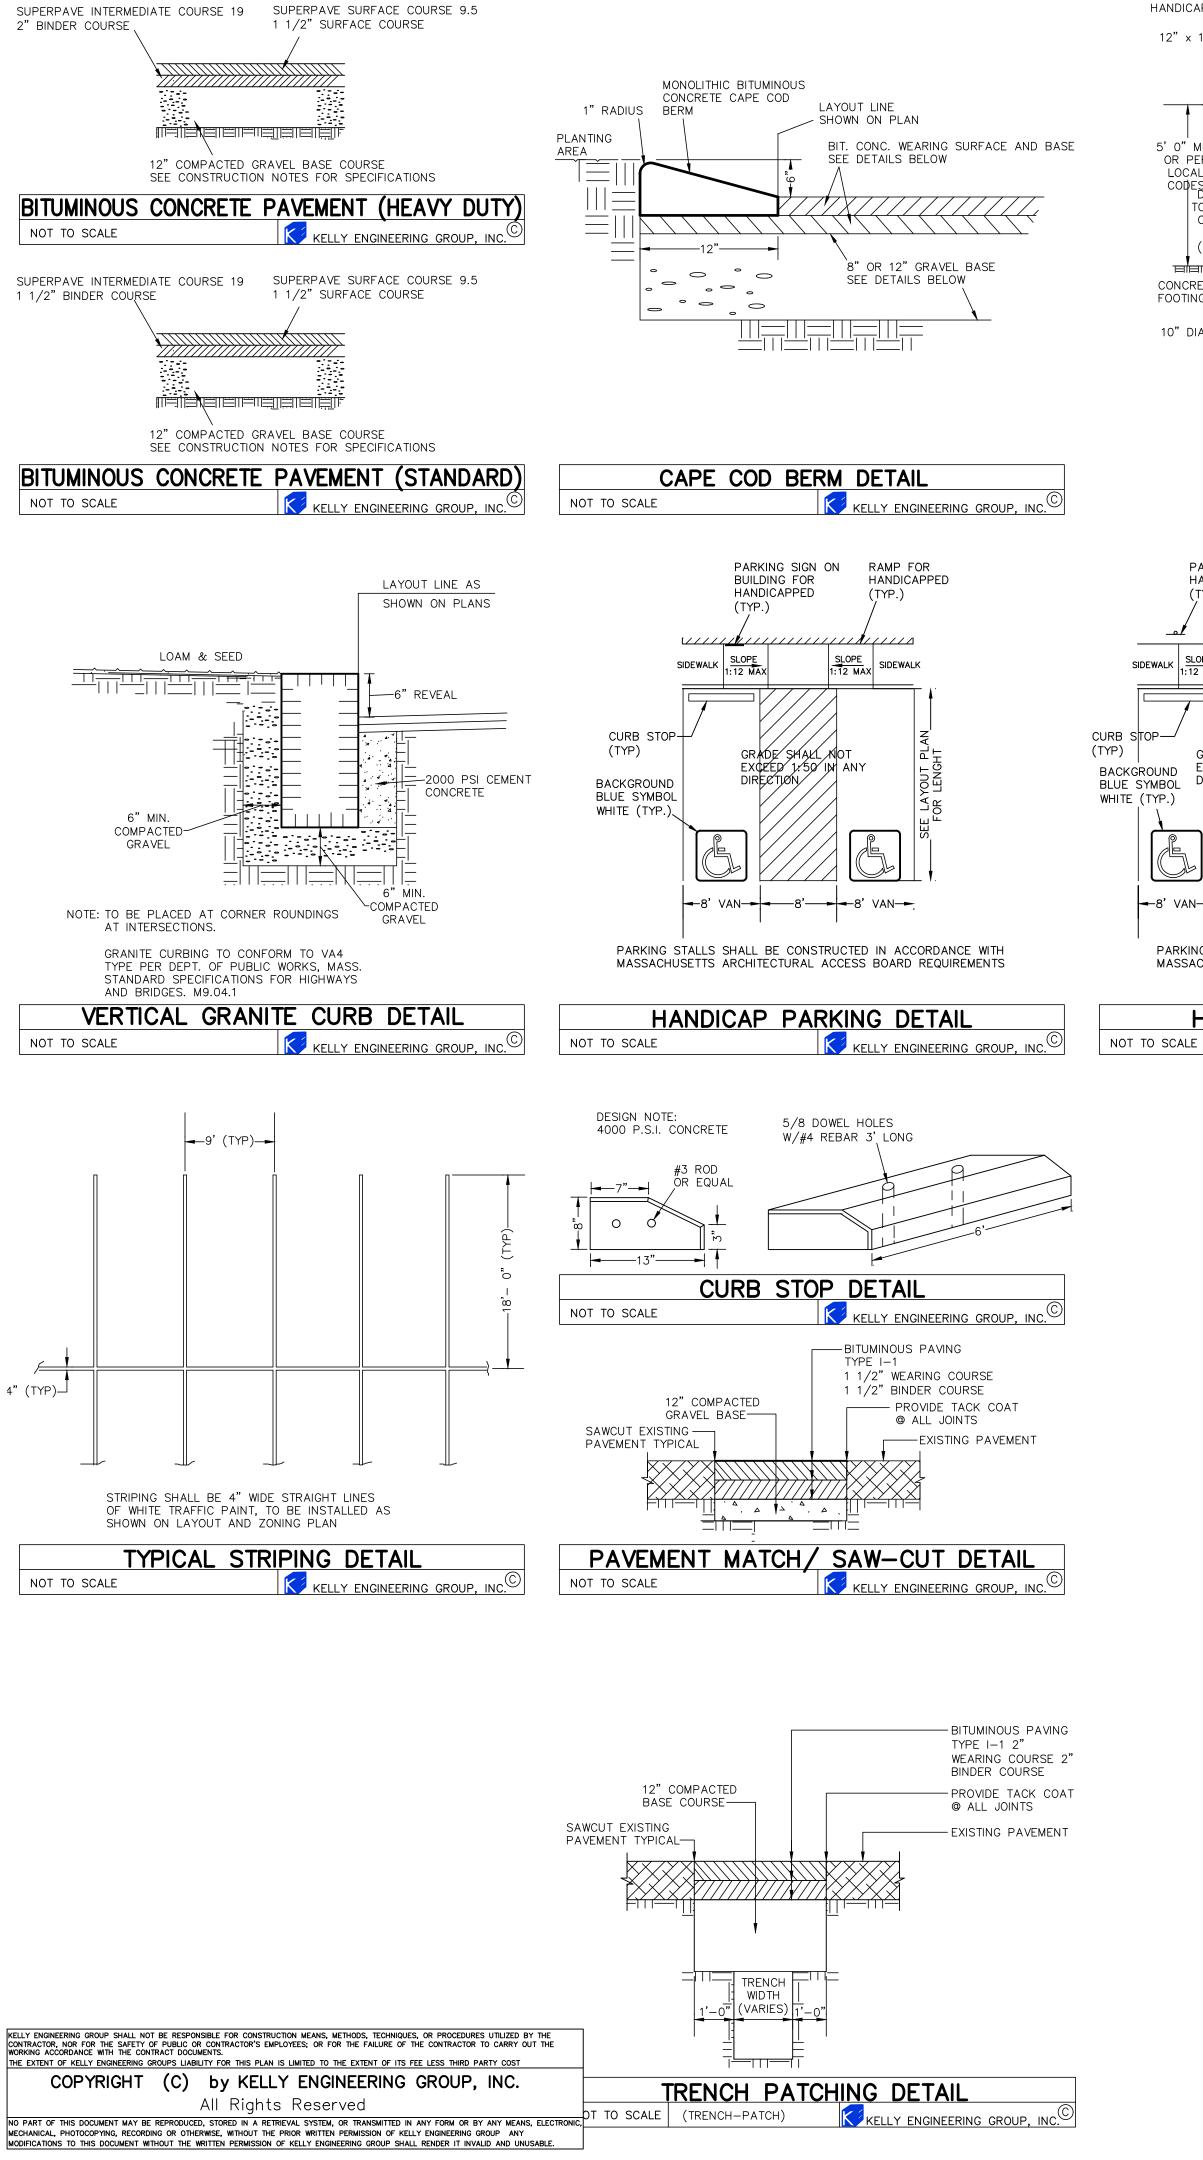
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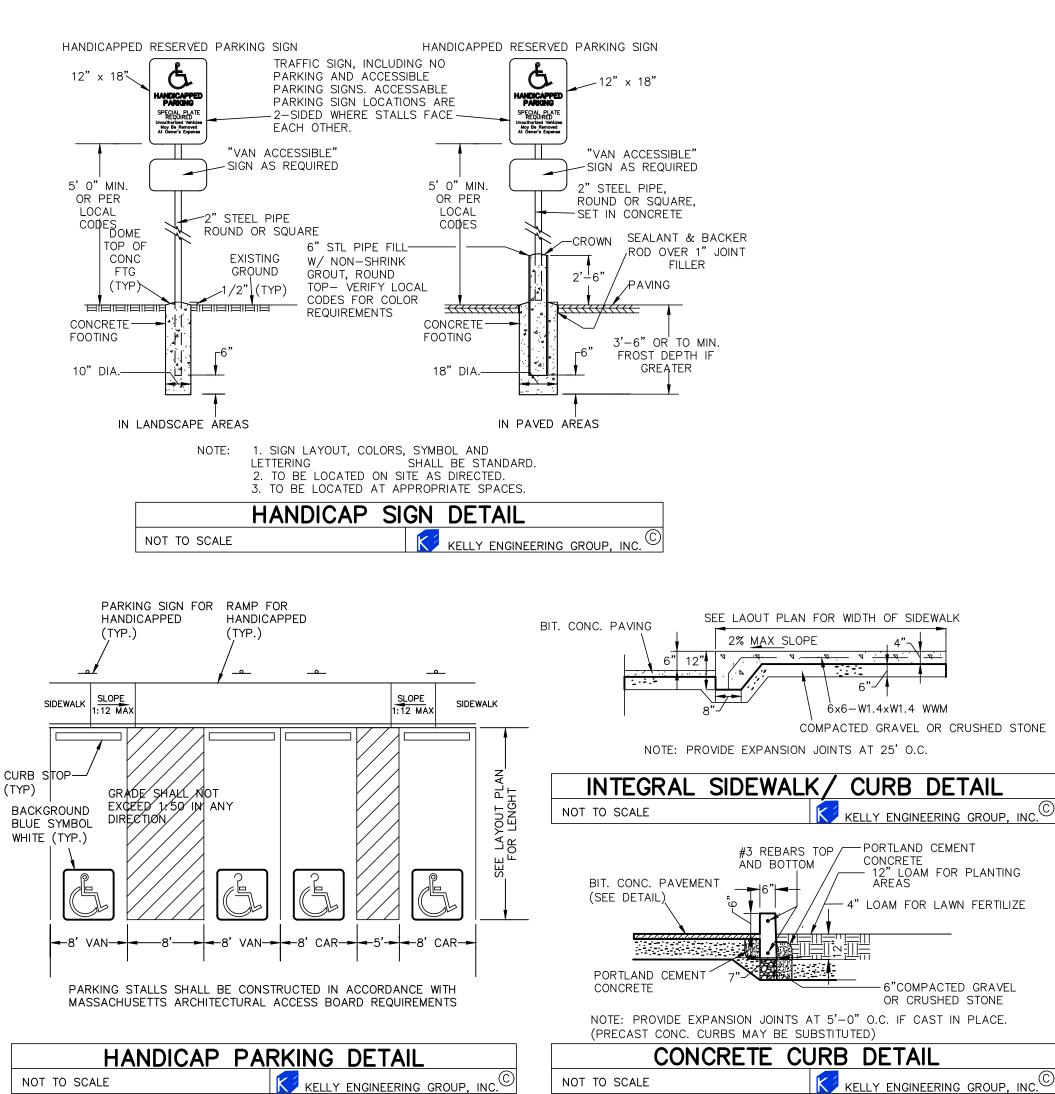
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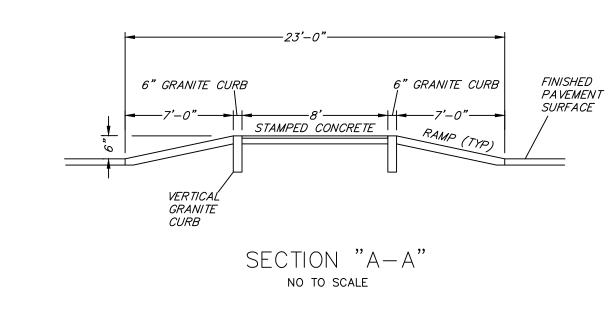
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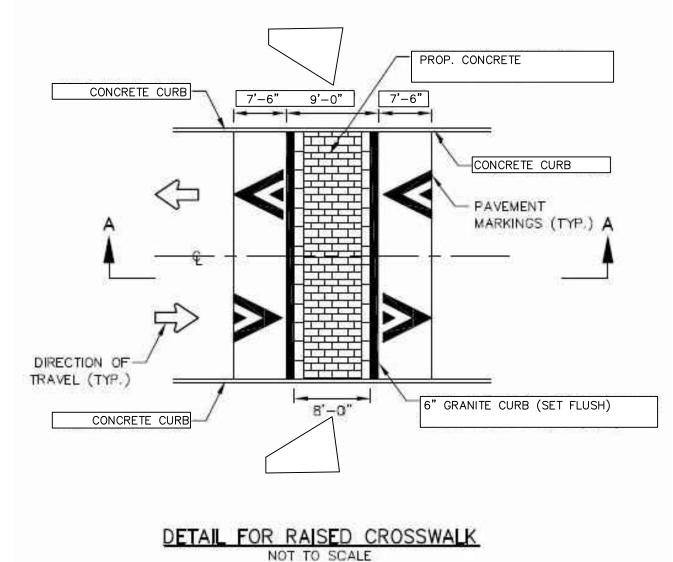
(E) BLDG

REV. **EROSION CONTROL** C-8







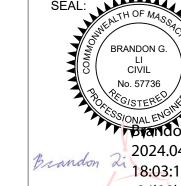

## CONSTRUCTION NOTES

ACTIVITIES.

RCP SHALL BE CLASS III.

A1. THE CONTRACTOR SHALL REPORT TO THE OWNER AND ENGINEER OF ANY SIGNIFICANT VARIATIONS IN EXISTING SITE CONDITIONS FROM THOSE SHOWN ON THESE PLANS. ANY PROPOSED REVISIONS TO THE WORK, IF REQUIRED BY THESE SITE CONDITIONS, SHALL NOT BE UNDERTAKEN UNTIL REVIEWED AND APPROVED BY THE OWNER AND THE ENGINEER.

PUBLIC WORKS AT LEAST 48 HOURS IN ADVANCE OF ANY REQUIRED INSPECTIONS. A3. IN ORDER TO PROTECT THE PUBLIC SAFETY DURING CONSTRUCTION, THE

AND POLICE OFFICERS. A4. ALL WORK SHALL CONFORM TO A SITE PLAN APPROVAL & STORMWATER MANAGEMENT APPROVAL TO BE ISSUED BY THE TOWN OF AYER PLANNING BOARD.

A6. ALL WORK SHALL CONFORM TO A DETERMINATION OF APPLICATION TO BE ISSUED BY THE TOWN OF AYER CONSERVATION COMMISSION. A7. ALL WORK SHALL CONFORM TO THE GEOTECHNICAL REPORT BY NORTHEAST GEOTECHNICAL, INC DATED, 2022 A8. THE LOCATION OF UNDERGROUND UTILITIES AS REPRESENTED ON THESE PLANS IS BASED UPON PLANS AND INFORMATION PROVIDED BY THE RESPECTIVE UTILITY COMPANIES OR MUNICIPAL DEPARTMENTS SUPPLEMENTED BY FIELD IDENTIFICATION WHEREVER POSSIBLE. NO WARRANTY IS MADE AS TO THE ACCURACY OF THESE LOCATIONS OR THAT ALL UNDERGROUND UTILITIES ARE SHOWN. THE CONTRACTOR SHALL CONTRACT DIG SAFE AT LEAST 72 HOURS PRIOR

TO THE START OF CONSTRUCTION. DIG SAFE TELEPHONE NUMBER IS

1-888-344-7233. A9. THE CONTRACTOR SHALL VERIFY THE LOCATION, SIZE AND DEPTH OF EXISTING UTILITIES PRIOR TO TAPPING INTO, CROSSING OR EXTENDING THEM. IF THE NEW WORK POSES A CONFLICT WITH EXISTING UTILITIES, THE ENGINEER SHALL BE NOTIFIED PRIOR TO THE CONTRACTOR CONTINUING. A10. REFER TO ARCHITECTURAL PLANS FOR EXACT BUILDING DIMENSION AND DOOR LOCATIONS.

A11. BENCHMARK ELEVATION IS AS SHOWN ON PLAN LOCATED AT HYDRANT IN FRONT OF BUILDING. DATUM IS NAVD 88. A12. ALL PROPOSED SITE GAS, ELECTRIC, TELEPHONE, CATV FEATURES SHOWN ON SITE DEVELOPMENT PLANS ARE INTENDED AS A GUIDE ONLY. FINAL CONFIGURATION TO BE CONFIRMED WITH PROJECT MEP ENGINEER AND UTILITY

B1. REFER TO PLUMBING PLANS FOR EXACT SIZE AND LOCATION OF SANITARY AND WATER CONNECTIONS. B2. REFER TO ELECTRICAL PLANS FOR THE LIGHTING CIRCUITS, FIXTURE DETAIL AND BUILDING CONNECTION LOCATION. B3. ALL H.D.P.E. HIGH DENSITY POLYETHYLENE PIPE SHALL BE ADS N-12 OR APPROVED EQUAL. SEWER SHALL BE SDR 35 WITH RUBBER RING JOINTS. WATER LINES SHALL BE CL 52 D.I.P. (DUCTILE IRON PIPE), REINFORCED CONCRETE PIPE

B4. NO LEDGE, BOULDERS, OR OTHER UNYIELDING MATERIALS ARE TO BE LEFT WITHIN 6" OF THE SEWER IN THE TRENCH, NOR ARE THEY TO BE USED FOR BACKFILL FOR THE FIRST 12" ABOVE THE PIPES. 1. WALKS SHALL BE 4" THICK AND SHALL BE CONSTRUCTED ON 6" OF COMPACTED BANK GRAVEL. CONCRETE FOR WALKS SHALL HAVE A MINIMUM 28 DAY COMPRESSION STRENGTH OF 4,000 PSI. WALKS SHALL BE REINFORCED WITH

WWM 6x 6 W1.4/W1.4 CONFORMING TO ASTM A184. C2. BASE MATERIAL SHALL BE CLEAN BANK RUN GRAVEL, CONFORMING TO M.D.P.W. M1.03.1, WITH NO STONES LARGER THAN THREE (3) INCHES IN DIAMETER AND SHALL BE PLACED AND ROLLED WITH AT LEAST A TEN TON ROLLER. THE SURFACES SHALL BE WET DURING ROLLING TO BIND THE MATERIAL. ALL STONES OF 4" DIAMETER OR LARGER SHALL BE REMOVED FROM THE SUB-BASE PRIOR TO PLACING BASE MATERIAL. PULVERIZED MATERIAL MAY BE USED AS BASE MATERIAL PROVIDING IT MEETS THIS SPECIFICATIONS. AREAS TO BE REPAVED SHALL BE PULVERIZED AND REGRADED TO PROVIDE POSITIVE FLOW TO DRAINAGE AND AWAY FROM BUILDING. PAVE WITH 1 1/2" WEARING COURSE ON 1 1/2" BINDER COURSE. ALL VALVES BOXES, MANHOLES AND OTHER UTILITIES APPURTENANCES SHALL BE ADJUSTED TO CONFORM TO FINAL GRADE

C3. TRANSFORMER PAD SHALL BE INSTALLED PER PROVIDERS SPECIFICATIONS. GENORATOR PADS SHALL BE INSTALLED PER MANUFACTURING SPECIFICATIONS. C4. PAVEMENT AREA SHALL BE PAVED TO A THICKNESS AS SHOWN ON THE PLANS MEASURED AFTER COMPACTION, WITH A SUPERPAVE INTERMEDIATE COURSE AND SUPERPAVE SURFACE COURSE. C5. THE AGGREGATE SHALL BE COMPOSED, MIXED AND LAID HOT IN TWO COURSES AS SPECIFIED IN THE "COMMONWEALTH OF MASSACHUSETTS STANDARD SPECIFICATIONS FOR HIGHWAYS AND BRIDGE", 2021 EDITION. SECTION 460 HOT MIX ASPHALT PAVEMENT FOR LOCAL STREETS.

FILL POST WITH CONCRETE AND ROUND TOP SMOOTH -4", 6", or 8" DIA. CLEAN PIPE TO WHITE METAL AND PAINT WITH ZINC RICH PRIMER AND FINISH COATS, COLOR TO BE YELLOW. CONCRETE — ASPHALT PAVEMENT (OR FINISH GRADE) - CONCRETE - 24" DIA. CONCRETE BASE -#6 - 14" LONG RE-BAR ËACH WAY THRU PIPE 12"-12"-

CONCRETE FILLED PIPE BOLLARD NOT TO SCALE KELLY ENGINEERING GROUP, INC.

C6. DUMPSTER PAD SHALL BE 8" THICK REINFORCED CONCRETE SLAB WITH CONTROL JOINTS EVERY 10'. THE PAD SHALL BE CONSTRUCTED OVER 6" OF GRAVEL BASE, COMPACT TO 95% REINFORCEMENT SHALL BE WWF 6x6- W1.4 x W1.4 PLACED AT THE CENTER OF THE SLAB. THE FRONT END OF COMPACTOR PAD SHALL HAVE EMBEDDED A 6"x 6"x 3/8" STEEL ANGLE. A2. THE CONTRACTOR SHALL NOTIFY THE TOWN OF AYER DEPARTMENT OF

C7. THE DOLLY PADS SHALL BE 6" THICK REINFORCED CONCRETE SLABS WITH CONTROL JOINTS EVERY 10' AND ISOLATION JOINTS WHERE SLAB ABUTS BUILDING. THE PADS SHALL BE CONSTRUCTED OVER 12" OF GRAVEL BASE COMPACTED TO 95%. REINFORCEMENT SHALL BE WWF 6 x 6- 2 W1.4 x W1.4 PLACED AT CENTER CONTRACTOR IS RESPONSIBLE FOR INSTALLING AND MAINTAINING AT ALL TIMES OF SLAB. ALL NECESSARY SAFETY DEVICES AND PERSONNEL, WARNING LIGHTS, BARRICADES,

PAVEMENT TO REMAIN AND TACK COAT THE JOINT. C9. ANY PAVEMENT REMOVED FOR UTILITY TRENCH EXCAVATION OR OTHERWISE DAMAGED DURING CONSTRUCTION SHALL BE REPLACED WITH A PAVEMENT SECTION A5. FOR ANY PROJECT THAT INVOLVES 1 ACRE OR MORE OF DISTURBANCE CONSISTING OF 1 1/2" SUPERPAVE SURFACE COURSE OVERLAYING A 1 1/2" CONTRACTOR SHALL SECURE A NPDES PERMIT PRIOR TO BEGINNING ANY GRADING SUPERPAVE INTERMEDIATE COURSE OVERLAYING A 12" COMPACTED GRAVEL BASE

> D1. ALL AREAS TO BE PLANTED WITH GRASS SHALL BE TREATED WITH 100 POUNDS OF GROUND LIMESTONE PER 1,000 S.F. OF AREA PLANTED. ALL AREAS TO BE PLANTED WITH GRASS SHALL BE FERTILIZED WITH 10-10-10 AT THE RATE OF 1,000 POUNDS PER ACRE OR AS REQUIRED BY SOIL TEST. 40% OF THE NITROGEN SHALL BE ORGANIC FORM. D2. ALL LANDSCAPED AREAS TO BE LOAMED AND SEEDED SHALL HAVE THE

C8. ALL EXISTING PAVING TO BE DISTURBED SHALL BE CUT ALONG A STRAIGHT

LINE THROUGH ITS ENTIRE THICKNESS. BUTT NEW PAVING INTO THE EXISTING

FOLLOWING MIX. PERENNIAL RYE 25% KENTUCKY BLUE 25% CREEPING RED FESCUE OR PENNLAWN FESCUE SEED AT THE RATE OF 5#/1,000 S.F.

NO SILT OR DEBRIS LEAVES THE SITE.

OF AYER D.P.W./ STORMWATER PERSONAL.

D3. ALL DISTURBED AREAS TO BE LOAMED AND SEEDED SHALL HAVE A MINIMUM OF 4 INCHES OF TOPSOIL SPREAD EVENLY THROUGHOUT. PROVIDE EROSION CONTROL MEASURES AS NECESSARY TO PROVIDE SLOPE STABILITY UNTIL VEGETATION IS ESTABLISHED. (NOTE: IF THERE IS A CONFLICT BETWEEN THESE PLANS AND LANDSCAPE PLANS THE LANDSCAPE PLANS SHALL DICTATE. E1. THE CONTRACTOR SHALL REGULARLY INSPECT THE PERIMETER OF THE PROPERTY TO CLEANUP AND REMOVE LOOSE CONSTRUCTION DEBRIS BEFORE IT LEAVES THE SITE. ALL DEMOLITION DEBRIS SHALL BE PROMPTLY REMOVED FROM THE SITE TO A LEGAL DUMP SITE. ALL TRUCKS LEAVING THE SITE SHALL BE

E2. IT SHALL BE THE RESPONSIBILITY OF THE CONTRACTOR TO INSTITUTE

EROSION CONTROL MEASURES ON AN AS NECESSARY BASIS, SUCH THAT EXCESSIVE SOIL EROSION DOES NOT OCCUR. MEASURES SHALL INCLUDE SILT SACKS IN DRAINAGE INLETS, MULCHING AND PLANTING OF DISTURBED AREAS. E3. PRIOR TO THE COMMENCEMENT OF ANY OTHER WORK A SILT SACK SHALL BE INSTALLED IN EACH EXISTING DRAINAGE INLET. E4. AFTER INSTALLATION OF EACH DRAINAGE INLET A SILT SACK SHALL BE INSTALLED IN EACH INLET TO PREVENT SEDIMENT FROM ENTERING THE STORM DRAIN SYSTEM. E5. AT THE END OF CONSTRUCTION ALL DRAINAGE STRUCTURES ARE TO BE CLEANED OF SILT, STONES AND OTHER DEBRIS. E6. DURING CONSTRUCTION THE EROSION CONTROL MEASURES SHALL BE INSPECTED ONCE PER WEEK AND WITHIN 24 HOURS OF ANY STORM EVENT GENERATING MORE THAN 1/2" OF RAINFALL. THE EROSION CONTROL MEASURES

E7. STABILIZATION MEASURES (SEEDING OR PLANTING, APPLYING MULCH OR OTHER NON-VEGETATIVE PRODUCT) OF EXPOSED SOILS SHALL BEGIN AS SOON AS PRACTICABLE AND IMMEDIATELY AFTER EARTH-DISTURBING ACTIVITIES HAVE PERMANENTLY OR TEMPORARILY CEASED. STABILIZATION TO BE COMPLETED WITHIN 14 DAYS.

SHALL BE CLEANED REGULARLY AND ADJUSTED IF NECESSARY TO ENSURE THAT

E8. SILT SOCKS SHALL BE INSTALLED ON THE DOWNSTREAM SIDE OF ALL STOCK E9. SPARE EROSION/SEDIMENT CONTROL MATERIALS SHALL BE AVAILABLE ON

F1. ALL STORM DRAIN INLETS SHOWN TO BE ABANDONED SHALL BE ABANDONED AS FOLLOWS SUCH THAT THE TOPS ARE NO LESS THAN 3' FROM FINISHED GRADE: (A) PRECAST DRAINAGE INLETS SHALL HAVE THE GRATE, FRAME AND CONE SECTION REMOVED. THE STORM DRAIN PIPE SHALL BE PLUGGED USING BRICK AND MORTAR AND THE REMAINING STRUCTURE SHALL BE BACK FILLED AND COMPACTED, OR THE ENTIRE STRUCTURE SHALL BE REMOVED AND REMAINING VOID SHALL BE BACKFILLED AND COMPACTED. (B) BLOCK DRAINAGE INLETS SHALL BE GRATE AND FRAMED REMOVED AND THE STORM DRAIN PLUGGED AS IN (A) ABOVE. THE STRUCTURE SHALL THEN BE CRUSHED, BACKFILLED AND COMPACTED.

SITE FOR USE IN CONTINGENCY CONDITIONS OR AT THE DIRECTION OF THE TOWN

F2. ALL STORM DRAINS TO BE ABANDONED WHICH ARE WITHIN 3' OF FINISHED GRADE SHALL BE REMOVED. ALL OTHERS SHALL BE PLUGGED AT EACH END.

CONTRACTOR:

PROJECT:



BAUM CM Enginering a-1311, 167 Songpa-daero Songpa-gu, Seoul 05855

No. 954578431

DESIGNER:



Nasoya Food Factory

**Expansion and Renovation** 

Project

SUBCONTRACTOR -CIVIL ENGINEER:




**KELLY ENGINEERING GROUP** civil engineering consultants 0 Campanelli Drive, Braintree, MA 02184 Phone: 781-843-4333 www.kellyengineeringgroup.com

NOTES:

ISSUE RECORD:

12 APR 24 E SITE PLAN MODIFICATION D PICK & PACK PERMIT 08 APR 24 08 APR 24 C DESIGN DEVELOPMENT 04 MAR 24 B | CORRECTED SD 02/07/24 SCHEMATIC DESCRIPTION DATE

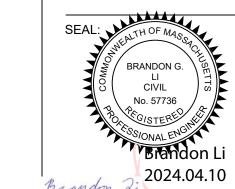

18:04:02 -04'00'

KEY PLAN

(E) BLDG

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(E) BLDG

D. ANTHOLZ 08 APR 2024

PROJECT #:

SHEET TITLE:

FACTORY EXPANSION AND RENOVATION 7 ONE NEW ENGLAND WAY

AYER, MA


SHEET NUMBER:

**DETAILS** 

REV. **C-9** 

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PROJECT:

Nasoya Food Factory **Expansion and Renovation** Project

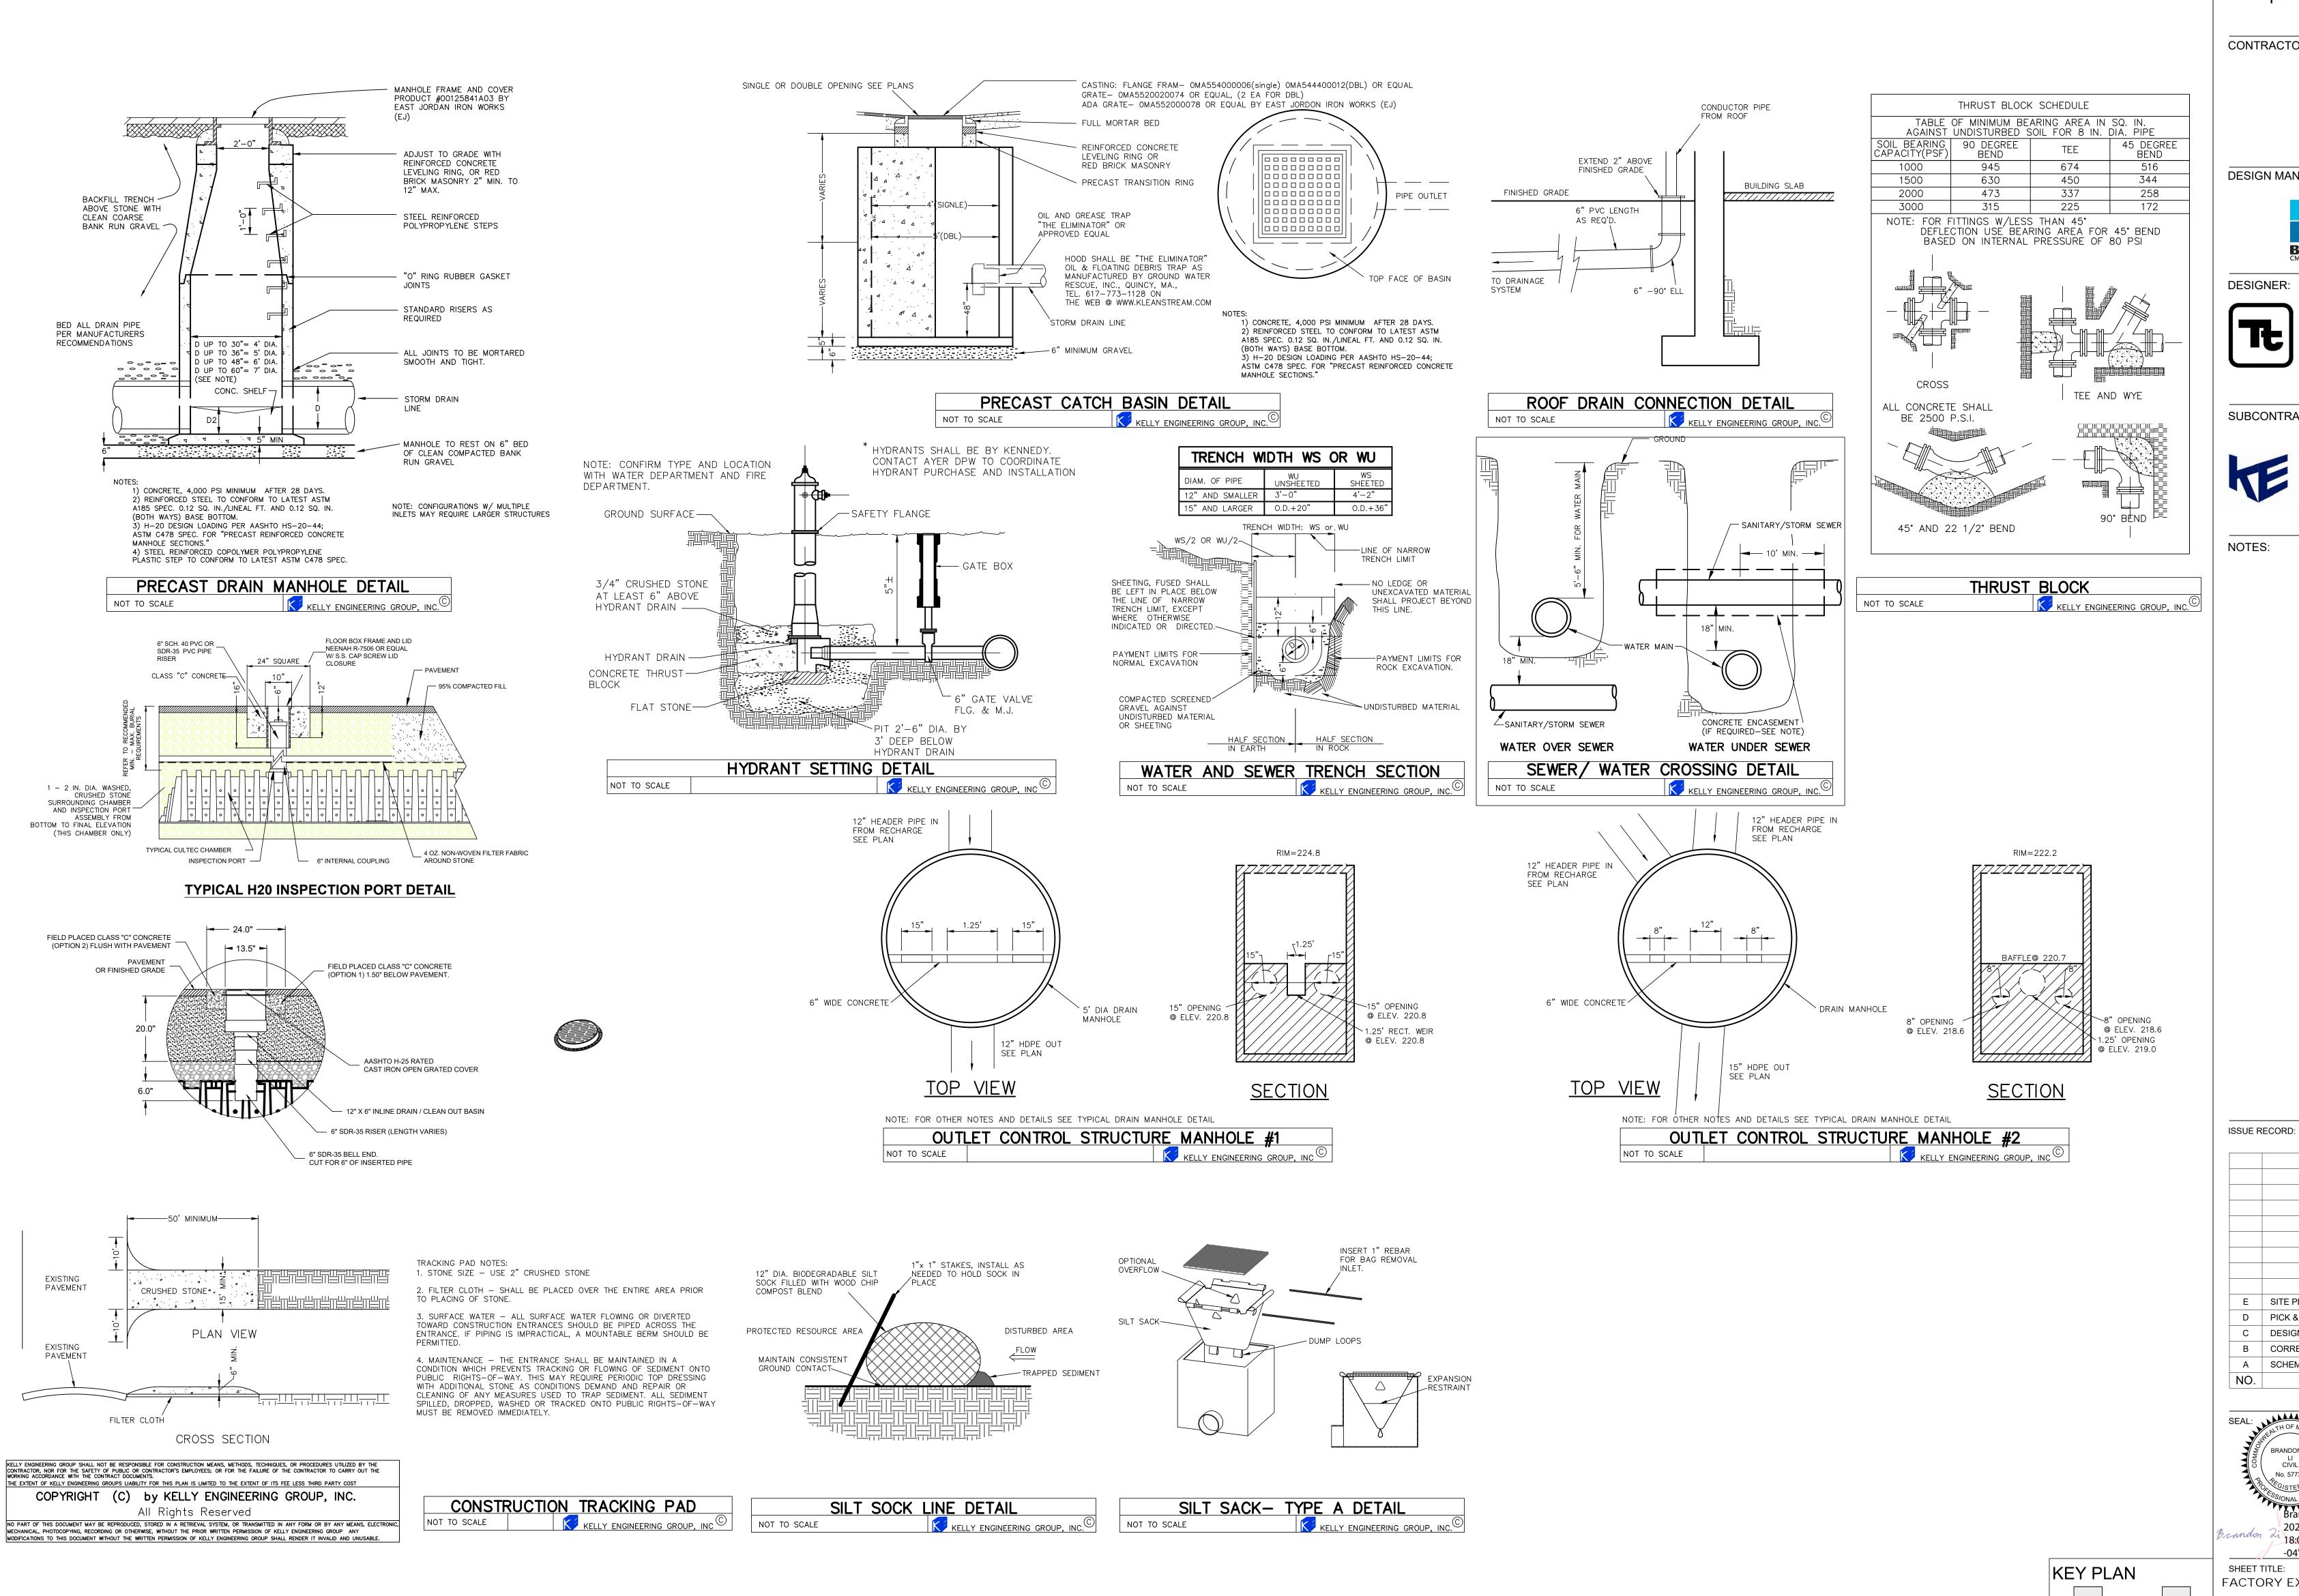CONTRACTOR:

**DESIGN MANAGER:** 



**BAUM CM Enginering** a-1311, 167 Songpa-daero Songpa-gu, Seoul 05855

DESIGNER:




SUBCONTRACTOR -CIVIL ENGINEER:



KELLY ENGINEERING GROUP civil engineering consultants O Campanelli Drive, Braintree, MA 02184 Phone: 781-843-4333 www.kellyengineeringgroup.com

NOTES:

Е	SITE PLAN MODIFICATION	12 APR
D	PICK & PACK PERMIT	08 APR
С	DESIGN DEVELOPMENT	08 APR
В	CORRECTED SD	04 MAF
Α	SCHEMATIC	02/07/
NO.	DESCRIPTION	DAT

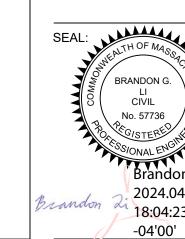

(E) BLDG

D

(E) BLDG

APPROVED BY: D. ANTHOLZ 2024.04.10 18:04:23 08 APR 2024

SHEET TITLE:


FACTORY EXPANSION AND RENOVATION \$\overline{\pi}\$ ONE NEW ENGLAND WAY

AYER, MA SHEET NUMBER:

> **DETAILS** C-10

REV.

\*SEE CULTEC RECHARGER 330XLHD STORMWATER MANAGEMENT SYSTEM DESIGN FOR INSTALLATION INSTRUCTIONS PROPRIETARY SHOP DRAWINGS TO BE PROVIDED PRIOR TO INSTALLATION SINGLE LAYER

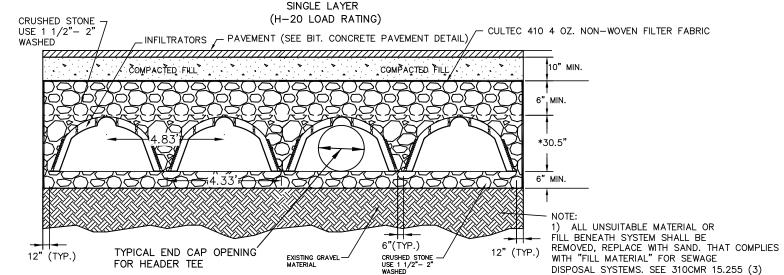

\*18.5" FOR 150XLHD SYSTEM SECTION 1—1 (PARTIAL)

STORMWATER MANAGEMENT SYSTEM CONSTRUCTION OPERATION + MAINTENANCE NOTES:

1. EXTREME CARE SHALL BE TAKEN DURING CONSTRUCTION TO AVOID SILTATION DURING THE CONSTRUCTION PROCESS. SILT CAGES AND HAYBALE DIKES SHALL BE INSPECTED DAILY AND REPLACED IF NECESSARY 2. EXTREME CARE SHALL BE TAKEN TO PREVENT COMPACTION OF UNDISTURBED SOILS BENEATH RECHARGE SYSTEM. 3. THERE SHALL BE NO DISCHARGE OF WATER FOR CONSTRUCTION DEWATERING ACTIVITIES INTO THE STORMWATER 4. THERE SHALL BE NO DISCHARGE OF STORMWATER INTO THE RECHARGE SYSTEM UNTIL THE SITE HAS BEEN

STABILIZED. CONSTRUCTION INSPECTION AND MAINTENANCE SCHEDULE:

1. WEEKLY INSPECTIONS SHALL BE PERFORMED BY THE APPLICANTS ENGINEER AND A REPRESENTATIVE FROM

2. INSPECTIONS SHALL INCLUDE THE PAVEMENT TO DETERMINE IF ACCUMULATED SEDIMENT IS TO BE REMOVED, OF THE CATCH BASINS TO DETERMINE DEPTH OF SEDIMENTS AND REQUIRED CLEANING, INSPECTION OF THE STORMCEPTOR TO DETERMINE IF CLEANING IS NECESSARY AND INSPECTION OF THE LEACHING SYSTEM SHALL BE CONDUCTED BY THE ENGINEER AND THE TOWN'S ENGINEERING DEPARTMENT.

3. AN INSPECTION OF THE EXCAVATION OF THE LEACHING SYSTEM SHALL BE CONDUCTED BY THE ENGINEER AND A REPRESENTATIVE THE TOWN'S ENGINEERING DEPARTMENT PRIOR TO PLACEMENT OF ANY MATERIAL OR CHAMBERS.

CONSTRUCTION MAINTENANCE SCHEDULE

1. WHEN THE BINDER COURSE HAS BEEN INSTALLED THE PAVEMENT SHALL BE KEPT CLEAR OF ACCUMULATED SEDIMENTS. IF ACCUMULATED SEDIMENTS ARE DEPOSITED ON THE PAVEMENT THE SEDIMENT SHALL BE CLEANED IMMEDIATELY. THE PAVEMENT SHALL BE SWEPT AS NECESSARY BASED ON THE WEEKLY INSPECTIONS. THE CONTRACTOR SHALL INSPECT THE PAVEMENT ON A DAILY BASIS AND REMOVE ACCUMULATED SEDIMENTS AS NECESSARY.

2. "SILT SAKS" SHALL BE INSTALLED AT ALL CATCH BASIN AND DROP INLET LOCATIONS. THE CONTRACTOR SHALL INSPECT THE "SILT SAKS" ON A WEEKLY BASIS AND AFTER HEAVY RAINSTORMS AND EMPTIED BASED ON MANUFACTURERS RECOMMENDATIONS.

3. THE CATCH BASINS SHALL BE INSPECTED ON A WEEKLY BASIS ANDS AFTER HEAVY RAINSTORMS. THE CATCH BASINS SHALL BE CLEANED WHEN 6" OF SEDIMENT HAS ACCUMULATED IN THE SUMP. 4. THE STORMCEPTOR SHALL BE INSPECTED ON A WEEKLY BASIS AND AFTER HEAVY RAINSTORMS. THE STORMCEPTOR SHALL BE CLEANED BASED ON THE MANUFACTURERS RECOMMENDATIONS. 5. THE INFILTRATION GALLEYS SHALL BE INSPECTED ON A WEEKLY BASIS AND AFTER HEAVY RAINSTORMS AND


SHALL BE CLEANED WHEN 2" OF SEDIMENT HAS ACCUMULATED IN THE INLET CHAMBER.



#### TYPICAL ŞUBSURFACE RECHARGE AREA (CULTEC 180XLHD) PLAN VIEW (INFILTRATION TO BE CULTEC OR APPROVED EQUAL)

\*SEE CULTEC RECHARGER 180XLHD STORMWATER MANAGEMENT SYSTEM DESIGN FOR INSTALLATION INSTRUCTIONS PROPRIETARY SHOP DRAWINGS TO BE PROVIDED PRIOR TO INSTALLATION SINGLE LAYER

(H-20 LOAD RATING) \_\_INFILTRATORS \_\_PAVEMENT (SEE BIT. CONCRETE PAVEMENT DETAIL) / CULTEC 410 4 OZ. NON-WOVEN FILTER FABRIC

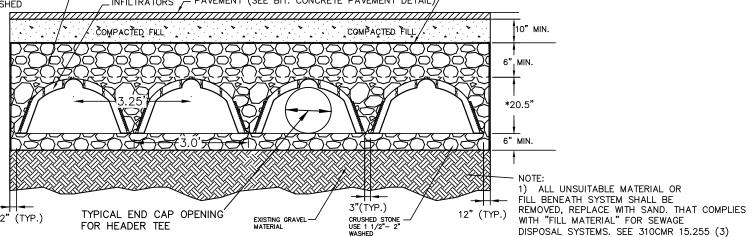

SECTION 1-1 (PARTIAL)

STORMWATER MANAGEMENT SYSTEM CONSTRUCTION OPERATION + MAINTENANCE NOTES: 1. EXTREME CARE SHALL BE TAKEN DURING CONSTRUCTION TO AVOID SILTATION DURING THE CONSTRUCTION PROCESS. SILT CAGES AND HAYBALE DIKES SHALL BE INSPECTED DAILY AND REPLACED IF NECESSARY 2. EXTREME CARE SHALL BE TAKEN TO PREVENT COMPACTION OF UNDISTURBED SOILS BENEATH RECHARGE SYSTEM. 3. THERE SHALL BE NO DISCHARGE OF WATER FOR CONSTRUCTION DEWATERING ACTIVITIES INTO THE STORMWATER

MANAGEMENT SYSTEM. 4. THERE SHALL BE NO DISCHARGE OF STORMWATER INTO THE RECHARGE SYSTEM UNTIL THE SITE HAS BEEN STABILIZED.

CONSTRUCTION INSPECTION AND MAINTENANCE SCHEDULE:

CONSTRUCTION INSPECTION SCHEDULE 1. WEEKLY INSPECTIONS SHALL BE PERFORMED BY THE APPLICANTS ENGINEER AND A REPRESENTATIVE FROM THE TOWN'S ENGINEERING DEPARTMENT.

2. INSPECTIONS SHALL INCLUDE THE PAVEMENT TO DETERMINE IF ACCUMULATED SEDIMENT IS TO BE REMOVED, OF THE CATCH BASINS TO DETERMINE DEPTH OF SEDIMENTS AND REQUIRED CLEANING, INSPECTION OF THE STORMCEPTOR TO DETERMINE IF CLEANING IS NECESSARY AND INSPECTION OF THE LEACHING SYSTEM SHALL BE CONDUCTED BY THE ENGINEER AND THE TOWN'S ENGINEERING DEPARTMENT. 3. AN INSPECTION OF THE EXCAVATION OF THE LEACHING SYSTEM SHALL BE CONDUCTED BY THE ENGINEER AND A REPRESENTATIVE THE TOWN'S ENGINEERING DEPARTMENT PRIOR TO PLACEMENT OF ANY

CONSTRUCTION MAINTENANCE SCHEDULE

MATERIAL OR CHAMBERS.


I. WHEN THE BINDER COURSE HAS BEEN INSTALLED THE PAVEMENT SHALL BE KEPT CLEAR OF ACCUMULATED SEDIMENTS. IF ACCUMULATED SEDIMENTS ARE DEPOSITED ON THE PAVEMENT THE SEDIMENT SHALL BE CLEANED IMMEDIATELY. THE PAVEMENT SHALL BE SWEPT AS NECESSARY BASED ON THE WEEKLY INSPECTIONS. THE CONTRACTOR SHALL INSPECT THE PAVEMENT ON A DAILY BASIS AND REMOVE ACCUMULATED SEDIMENTS AS

2. "SILT SAKS" SHALL BE INSTALLED AT ALL CATCH BASIN AND DROP INLET LOCATIONS. THE CONTRACTOR SHALL INSPECT THE "SILT SAKS" ON A WEEKLY BASIS AND AFTER HEAVY RAINSTORMS AND EMPTIED BASED ON MANUFACTURERS RECOMMENDATIONS. 3. THE CATCH BASINS SHALL BE INSPECTED ON A WEEKLY BASIS ANDS AFTER HEAVY RAINSTORMS. THE CATCH

BASINS SHALL BE CLEANED WHEN 6" OF SEDIMENT HAS ACCUMULATED IN THE SUMP. 4. THE STORMCEPTOR SHALL BE INSPECTED ON A WEEKLY BASIS AND AFTER HEAVY RAINSTORMS. THE STORMCEPTOR SHALL BE CLEANED BASED ON THE MANUFACTURERS RECOMMENDATIONS. 5. THE INFILTRATION GALLEYS SHALL BE INSPECTED ON A WEEKLY BASIS AND AFTER HEAVY RAINSTORMS AND SHALL BE CLEANED WHEN 2" OF SEDIMENT HAS ACCUMULATED IN THE INLET CHAMBER.



ANCHORED JUTE MESH SLOPE STABILIZATION. HYDROSEED WITH EROSION CONTROL GRASS MIX. TEMPORARY SEDIMENTATION AND EROSION CONTROL MEASURES SHALL BE IMPLEMENTED DURING 15' BENCH CONSTRUCTION AND LEFT IN PLACE UNTIL THE SLOPE SURFACE HAS BEEN PERMANENTLY STABILIZED.

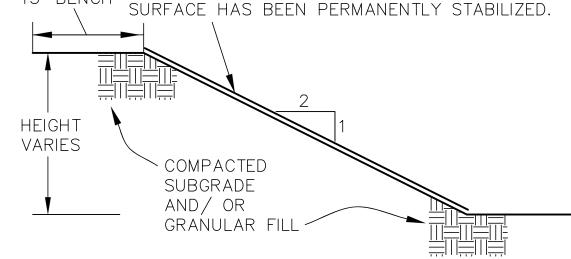

NOTES

CDS2015-4-C DESIGN NOTES


1. SLOPE TO BE FOUNDED ON UNDISTURBED MATERIAL AND CONSISTENT WITH GEOTECHNICAL ENGINEERS RECOMMENDATIONS.

2. CONSTRUCT FILL SLOPE USING GRANULAR FILL PLACED AND COMPACTED SYSTEMATICALLY IN LIFTS. MAXIMUM LOOSE LIFT THICKNESS SHALL NOT EXCEED 12 INCHES. COMPACT EACH LIFT TO 95% OF THE MATERIAL'S MAXIMUM DRY UNIT WEIGHT IN ACCORDANCE WITH ASTM D1557.

3. OVER-BUILD THE SLOPE AS NECESSARY TO ACHIEVE 95% COMPACTION AT THE DESIGN SLOPE FACE. CUT BACK EXCESS SOILS TO THE DESIGN SLOPE FACE USING AN EXCAVATOR EQUIPPED WITH A SMOOTH-EDGED BUCKET. TAMP THE SLOPE FACE WITH THE EXCAVATOR BUCKET.

4. THE PROPOSED SLOPE TO RECEIVE COMPACTED GRANULAR FILL SHALL FIRST BE CLEARED AND GRUBBED OF ALL FOREST, MAT TOPSOIL, SUBSOIL, STUMPS, ROOTS, DEBRIS AND OTHER ORGANIC OR DELETERIOUS MATERIAL. PROOF ROLLING/ COMPACTION SHALL BE PERFORMED ON RESULTANT SUBGRADE SURFACE. IN ACCORDANCE WITH GEOTECHNICAL ENGINEERS RECOMMENDATIONS.




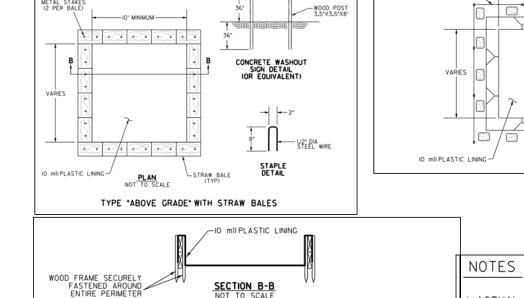

∠IO mīl PLASTIC LINING

SECTION B-B NOT TO SCALE


NATIVE MATERIAL (OPTIONAL)

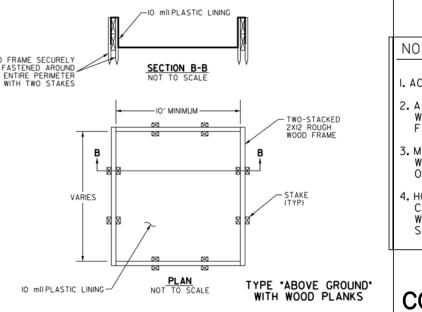



.ACTUAL LAYOUT TO BE DETERMINED IN THE FIELD. 2. A CONCRETE WASHOUT SIGN SHALL BE INSTALLED WITHIN 30' OF THE TEMPORARY CONCRETE WASHOUT .MATERIALS USED TO CONSTRUCT TEMPORARY CONCRET WASHOUT FACILITIES SHALL BE REMOVED FROM THE SITE OF THE WORK AND DISPOSED OF OR RECYCLED. 4. HOLES, DEPRESSIONS OR OTHER GROUND DISTURBANCE CAUSED BY THE REMOVAL OF THE TEMPORARY CONCRETE WASHOUT FACILITIES SHALL BE BACKFILLED, REPAIRED, AND STABILIZED TO PREVENT EROSION.

TYPE "BELOW GRADE"

#### CONCRETE WASHOUT DETAIL

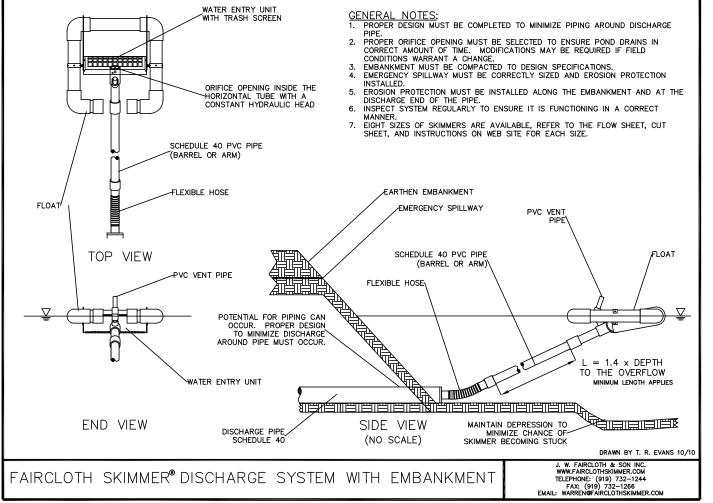

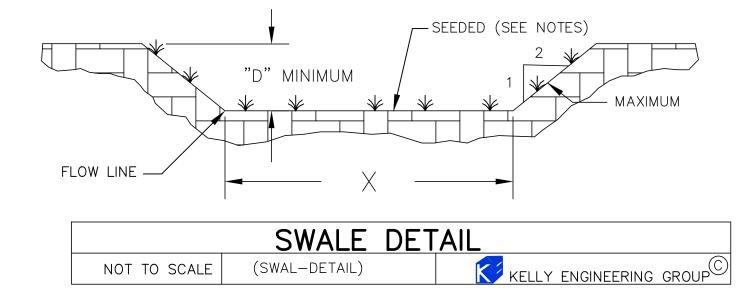

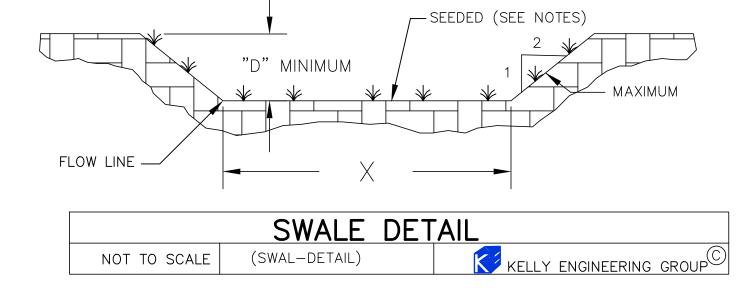

- IO' MINIMUM ----

IO mil PLASTIC LINING-

PROJECT:

CONTRACTOR:

DESIGN MANAGER:

**DESIGNER:** MASSACHUSETTS CORPORATION No. 954578431

Nasoya Food Factory

**Expansion and Renovation** 

Project

SUBCONTRACTOR -CIVIL ENGINEER:



KELLY ENGINEERING GROUP civil engineering consultants 0 Campanelli Drive, Braintree, MA 02184 Phone: 781-843-4333 www.kellyengineeringgroup.com

**BAUM CM Enginering** 


Songpa-gu, Seoul 05855


www.tetratech.com

a-1311, 167 Songpa-daero

NOTES:

ISSUE RECORD:

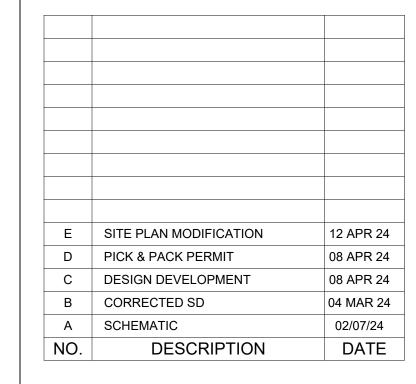

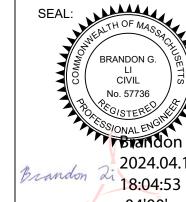

KEY PLAN

(E) BLDG

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(E) BLDG

Brandon Li APPROVED BY: D. ANTHOLZ 18:04:53 08 APR 2024 -04'00'

PROJECT #:

SHEET TITLE:


FACTORY EXPANSION AND RENOVATION 7 ONE NEW ENGLAND WAY AYER, MA


SHEET NUMBER:

**DETAILS** C-11

REV.

O N

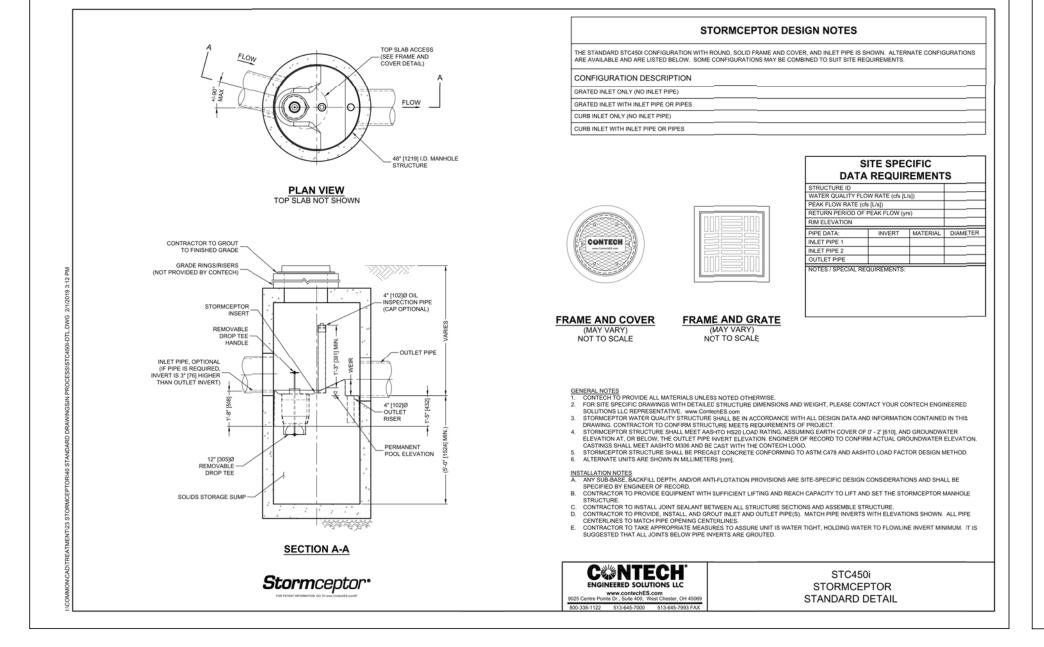

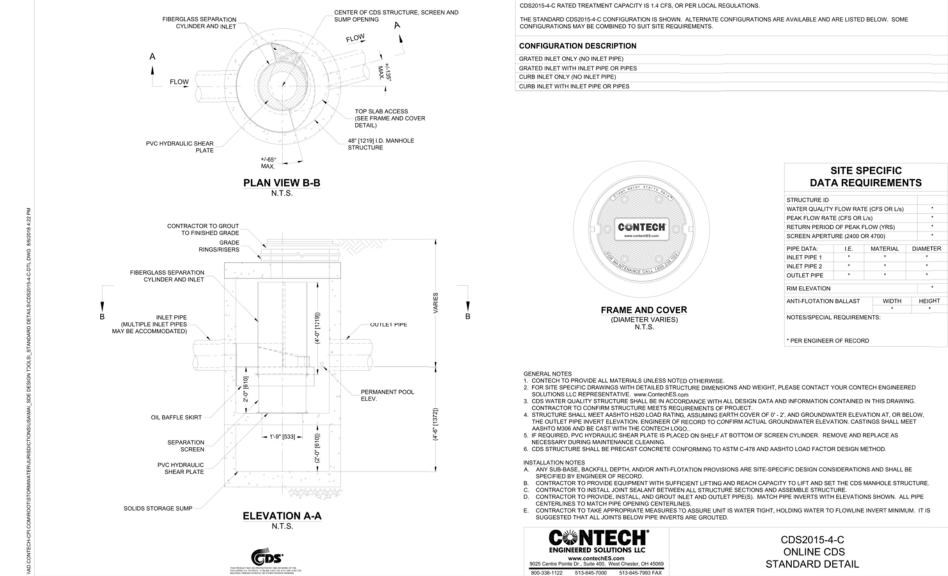

# SEDIMENT CONTROL

1. FOR ANY PROJECT THAT INVOLVES 1 ACRE OR MORE OF DISTURBANCE, CONTRACTOR SHALL SECURE A NPDES PERMIT PRIOR TO BEGINNING ANY GRADING ACTIVITIES. 2. PRIOR TO THE COMMENCEMENT OF ANY OTHER WORK A CONSTRUCTION FENCE SHALL BE INSTALLED AROUND THE EXISTING AND PROPOSED LIMITS OF WORK. TEMPORARY SEEDING - WITHIN 14 DAYS AFTER CONSTRUCTION ACTIVITY CEASES ON ANY PARTICULAR AREA. ALL DISTURBED GROUND WHERE THERE WILL NOT BE CONSTRUCTION FOR LONGER THAN 21 DAYS MUST BE SEEDED WITH FAST-GERMINATING TEMPORARY SEED AND PROTECTED WITH MULCH. 3. PER CONSTRUCTION GENERAL PERMIT, THE CONTRACTOR SHALL REGULARLY INSPECT THE PERIMETER OF THE PROPERTY TO CLEAN UP AND REMOVE LOOSE CONSTRUCTION DEBRIS BEFORE IT LEAVES THE SITE. ALL DEMOLITION DEBRIS SHALL BE PROMPTLY REMOVED FROM THE SITE TO A LEGAL DUMP SITE. ALL TRUCKS LEAVING THE SITE SHALL BE COVERED. 4. PRIOR TO THE COMMENCEMENT OF ANY OTHER WORK A SILT SACK SHALL BE INSTALLED IN EACH EXISTING DRAINAGE INLET. 5. AT THE END OF CONSTRUCTION ALL DRAINAGE STRUCTURES TO REMAIN SHALL BE CLEANED OF SILT, STONES AND OTHER DEBRIS. 6. DURING CONSTRUCTION THE SEDIMENT CONTROL MEASURES SHOWN ON THESE PLANS SHALL BE INSPECTED EVERY 7 CALENDAR DAYS AND WITHIN 24 HOURS OF ANY STORM EVENT GENERATING MORE THAN 1/2" OF RAINFALL. THE SEDIMENT CONTROL MEASURES SHALL BE CLEANED REGULARLY AND ADJUSTED IF NECESSARY TO ENSURE THAT NO SILT OR DEBRIS LEAVES THE SITE.

INITIAL MOBILIZATION PHASE: 1. INSTALLATION OF CONSTRUCTION SIGNAGE. 2. INSTALLATION OF CONSTRUCTION SECURITY FENCING AND GATES 3. INSTALLATION OF PERIMETER EROSION CONTROLS 4. CLEARING OF TREES IN THE AREA OF WORK


5. RE-ROUTE STORM DRAIN LINE I 6. STAKE OUT AND PROTECT AREAS FOR SUBSURFACE RECHARGE. 7. INSTALLATION OF TEMPORARY SEDIMENT PONDS. (NOTE: BASINS SHOWN ON PLAN ARE

APPROXIMATE ONLY. THE CONTRACTOR SHOULD SET THESE BMPs BASED ON CONSTRUCTION SCHEDULE AND SITE CONDITIONS). 8. BEGIN FOUNDATION WORK ON BUILDINGS #11, #1, AND #7. RE-ROUTE WATER AND GAS AS

SHOWN ON SITE PLANS. 9. CONTINUE SITE PREPARATION ON PERIMETER OF LAND, INCLUDING, CUTS AND FILLS. RETAINING WALLS, ETC., AND GRADE SITE TO TEMPORARY SEDIMENT PONDS. 9. CONTINUE WITH CONSTRUCTION OF DRAINAGE DETENTION PONDS AND STABILIZATION

10. CONSTRUCT CLOSED DRAINAGE SYSTEM. 11. ONCE DETENTION PONDS ARE SET. STORMWATER MAY BE DIVERTED TO THOSE PONDS. 12. ONGOING INSPECTIONS, INSTALLATION AND REPLACEMENT OF ANY NEW OR EXISTING EROSION CONTROLS MEASURES SHALL BE ADDED BY THE CONTRACTOR ON AN AS-NEEDED

NOTE: IF CONTRACTOR CHANGES ABOVE SEQUENCING NEW SEQUENCE SHALL BE PROVIDED TO PROJECT ENGINEER. TOWN ENGINEER AND TOWN OF NORTON CONSERVATION COMMISSION.

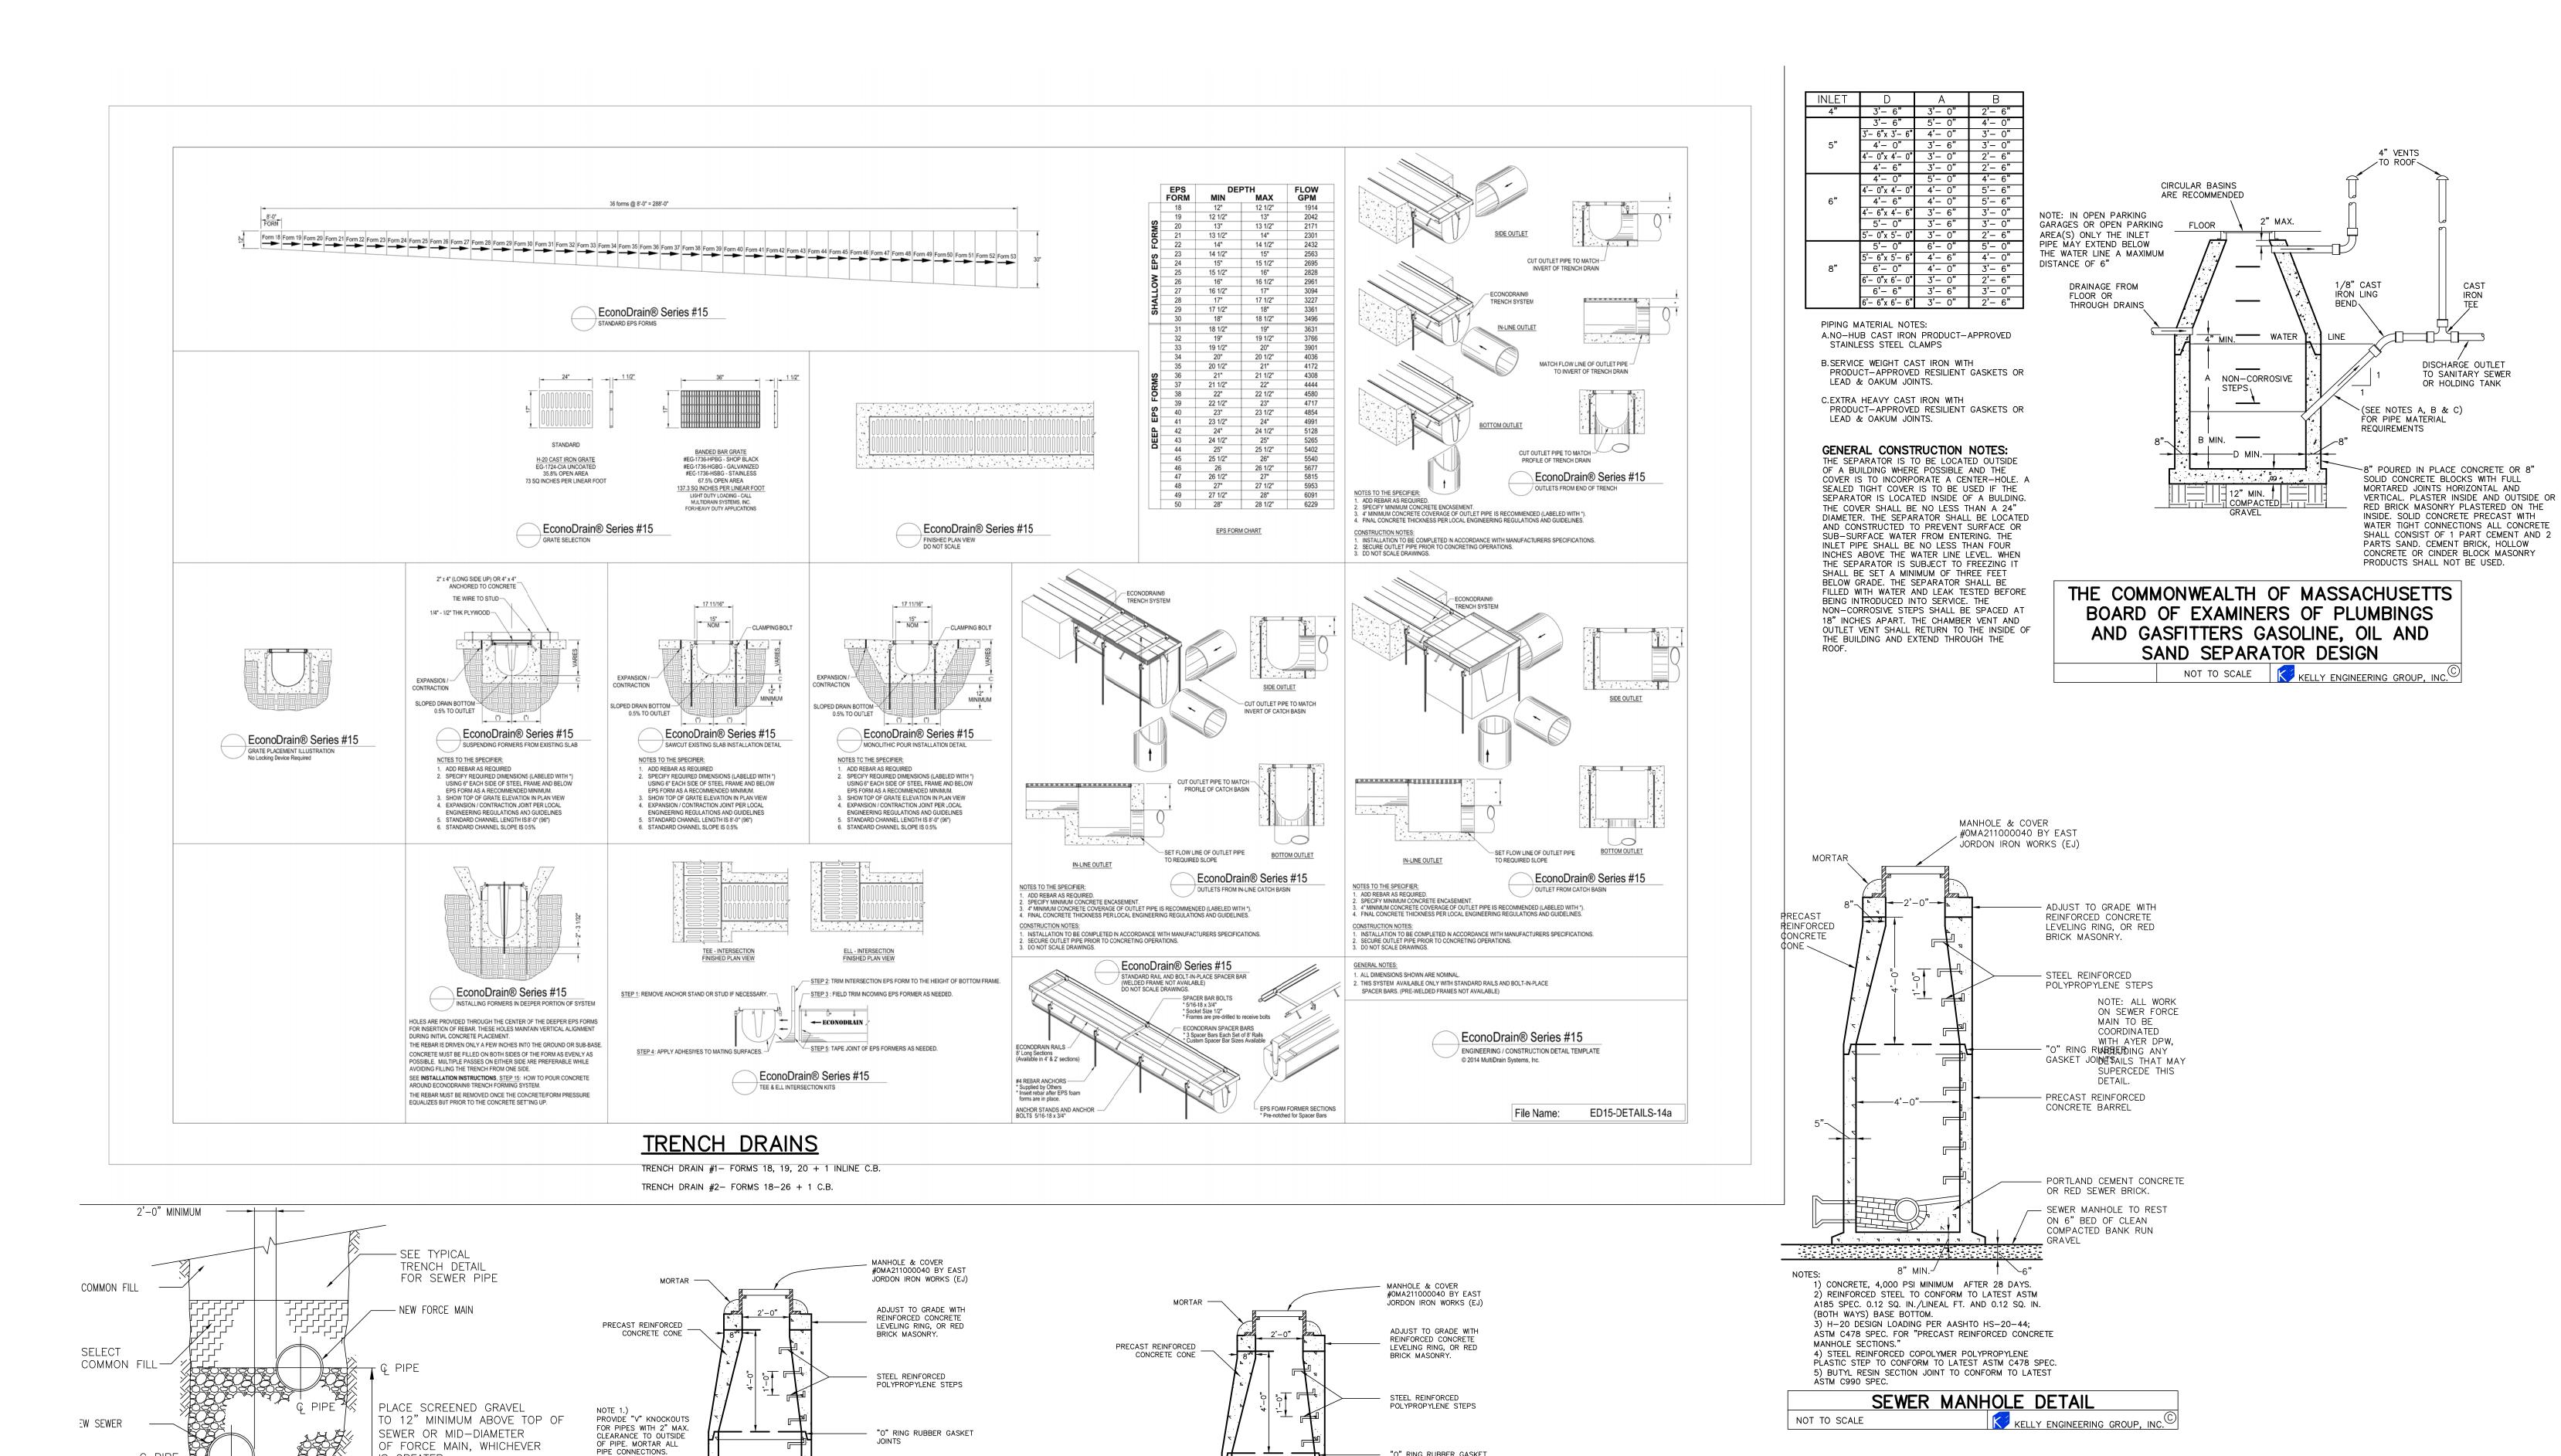

DI "Y" (TYP.)

WHERE PIPE COVER IS LESS THAN

4', PIPING AND FITTINGS IN MANHOLE SHALL BE INSULATED TO A MINIMUM "R" FACTOR OF 12

INSULATION SHALL BE PROTECTED WITH A WATERPROOF COVERING. —

CONCRETE BARREL

COMPACTED BANK RUN GRAVEL

\_1" AIR RELEASE VALVE

1" CORPORATION STOP SEWER MANHOLE TO REST

KELLY ENGINEERING GROUP, INC. CO

CONCRETE PIPE SUPPORT

NOTE: ALL WORK ON SEWER FORCE MAIN TO BE COORDINATED

AUTOMATIC AIR RELEASE SEWER MANHOLE DETAIL (SMH AIR)

WITH AYER DPW, INCLUDING ANY DETAILS THAT MAY SUPERCEDE

1" TAPPED OPENING

SEE NOTE 1.

IS GREATER.

— 8"MINIMUM

NOTE: ALL WORK ON SEWER FORCE MAIN TO BE COORDINATED WITH AYER DPW, INCLUDING ANY DETAILS THAT MAY SUPERCEDE

KELLY ENGINEERING GROUP SHALL NOT BE RESPONSIBLE FOR CONSTRUCTION MEANS, METHODS, TECHNIQUES, OR PROCEDURES UTILIZED BY THE CONTRACTOR, NOR FOR THE SAFETY OF PUBLIC OR CONTRACTOR'S EMPLOYEES; OR FOR THE FAILURE OF THE CONTRACTOR TO CARRY OUT THE WORKING ACCORDANCE WITH THE CONTRACT DOCUMENTS.

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COMMON TRENCH FOR SEWER AND FORCE MAIN

8" MINIMUM

UNDISTURBED EARTH/

CLEARANCE

IN ROCK

"O" RING RUBBER GASKET

\_45 DEGREE BEND W/ FLANGED END (TYP.)

PIPE SUPPORTS/RESTRAINTS (STAINLESS STEEL)

\_\_\_SANITARY PRESSURE SEWER

SEWER MANHOLE TO REST

FLEXIBLE WATER TIGHT GASKET OR SLEEVE

(FORCE MAIN)

CONCRETE BARREL


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KELLY ENGINEERING GROUP, INC. (C

NOTE: ALL WORK ON SEWER FORCE MAIN TO BE COORDINATED

SANITARY PRESSURE SEWER CLEANOUT MANHOLE (SMH CO)

WITH AYER DPW, INCLUDING ANY DETAILS THAT MAY SUPERCEDE

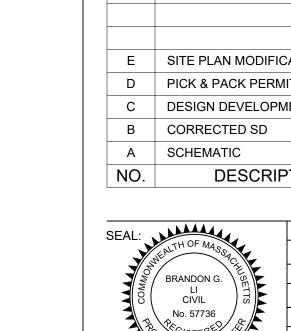

PROJECT #: 2024.04.10 18:05:26 -04'00'

D. MACKWELL APPROVED BY: D. ANTHOLZ 08 APR 2024

SHEET TITLE:

KEY PLAN

(E) BLDG

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(E) BLDG

ONE NEW ENGLAND WAY

SHEET NUMBER:

**DETAILS** C-12

REV.

NOT

Project CONTRACTOR:

Nasoya Food Factory

**Expansion and Renovation** 

**DESIGN MANAGER:** 

PROJECT:



**BAUM CM Enginering** a-1311, 167 Songpa-daero Songpa-gu, Seoul 05855

DESIGNER:



SUBCONTRACTOR -CIVIL ENGINEER:




KELLY ENGINEERING GROUP civil engineering consultants 0 Campanelli Drive, Braintree, MA 02184 Phone: 781-843-4333 www.kellyengineeringgroup.com

NOTES:

ISSUE RECORD:


12 APR 24 E SITE PLAN MODIFICATION D PICK & PACK PERMIT 08 APR 24 08 APR 24 C DESIGN DEVELOPMENT 04 MAR 24 02/07/24 DATE DESCRIPTION

FACTORY EXPANSION AND RENOVATION 7 AYER, MA

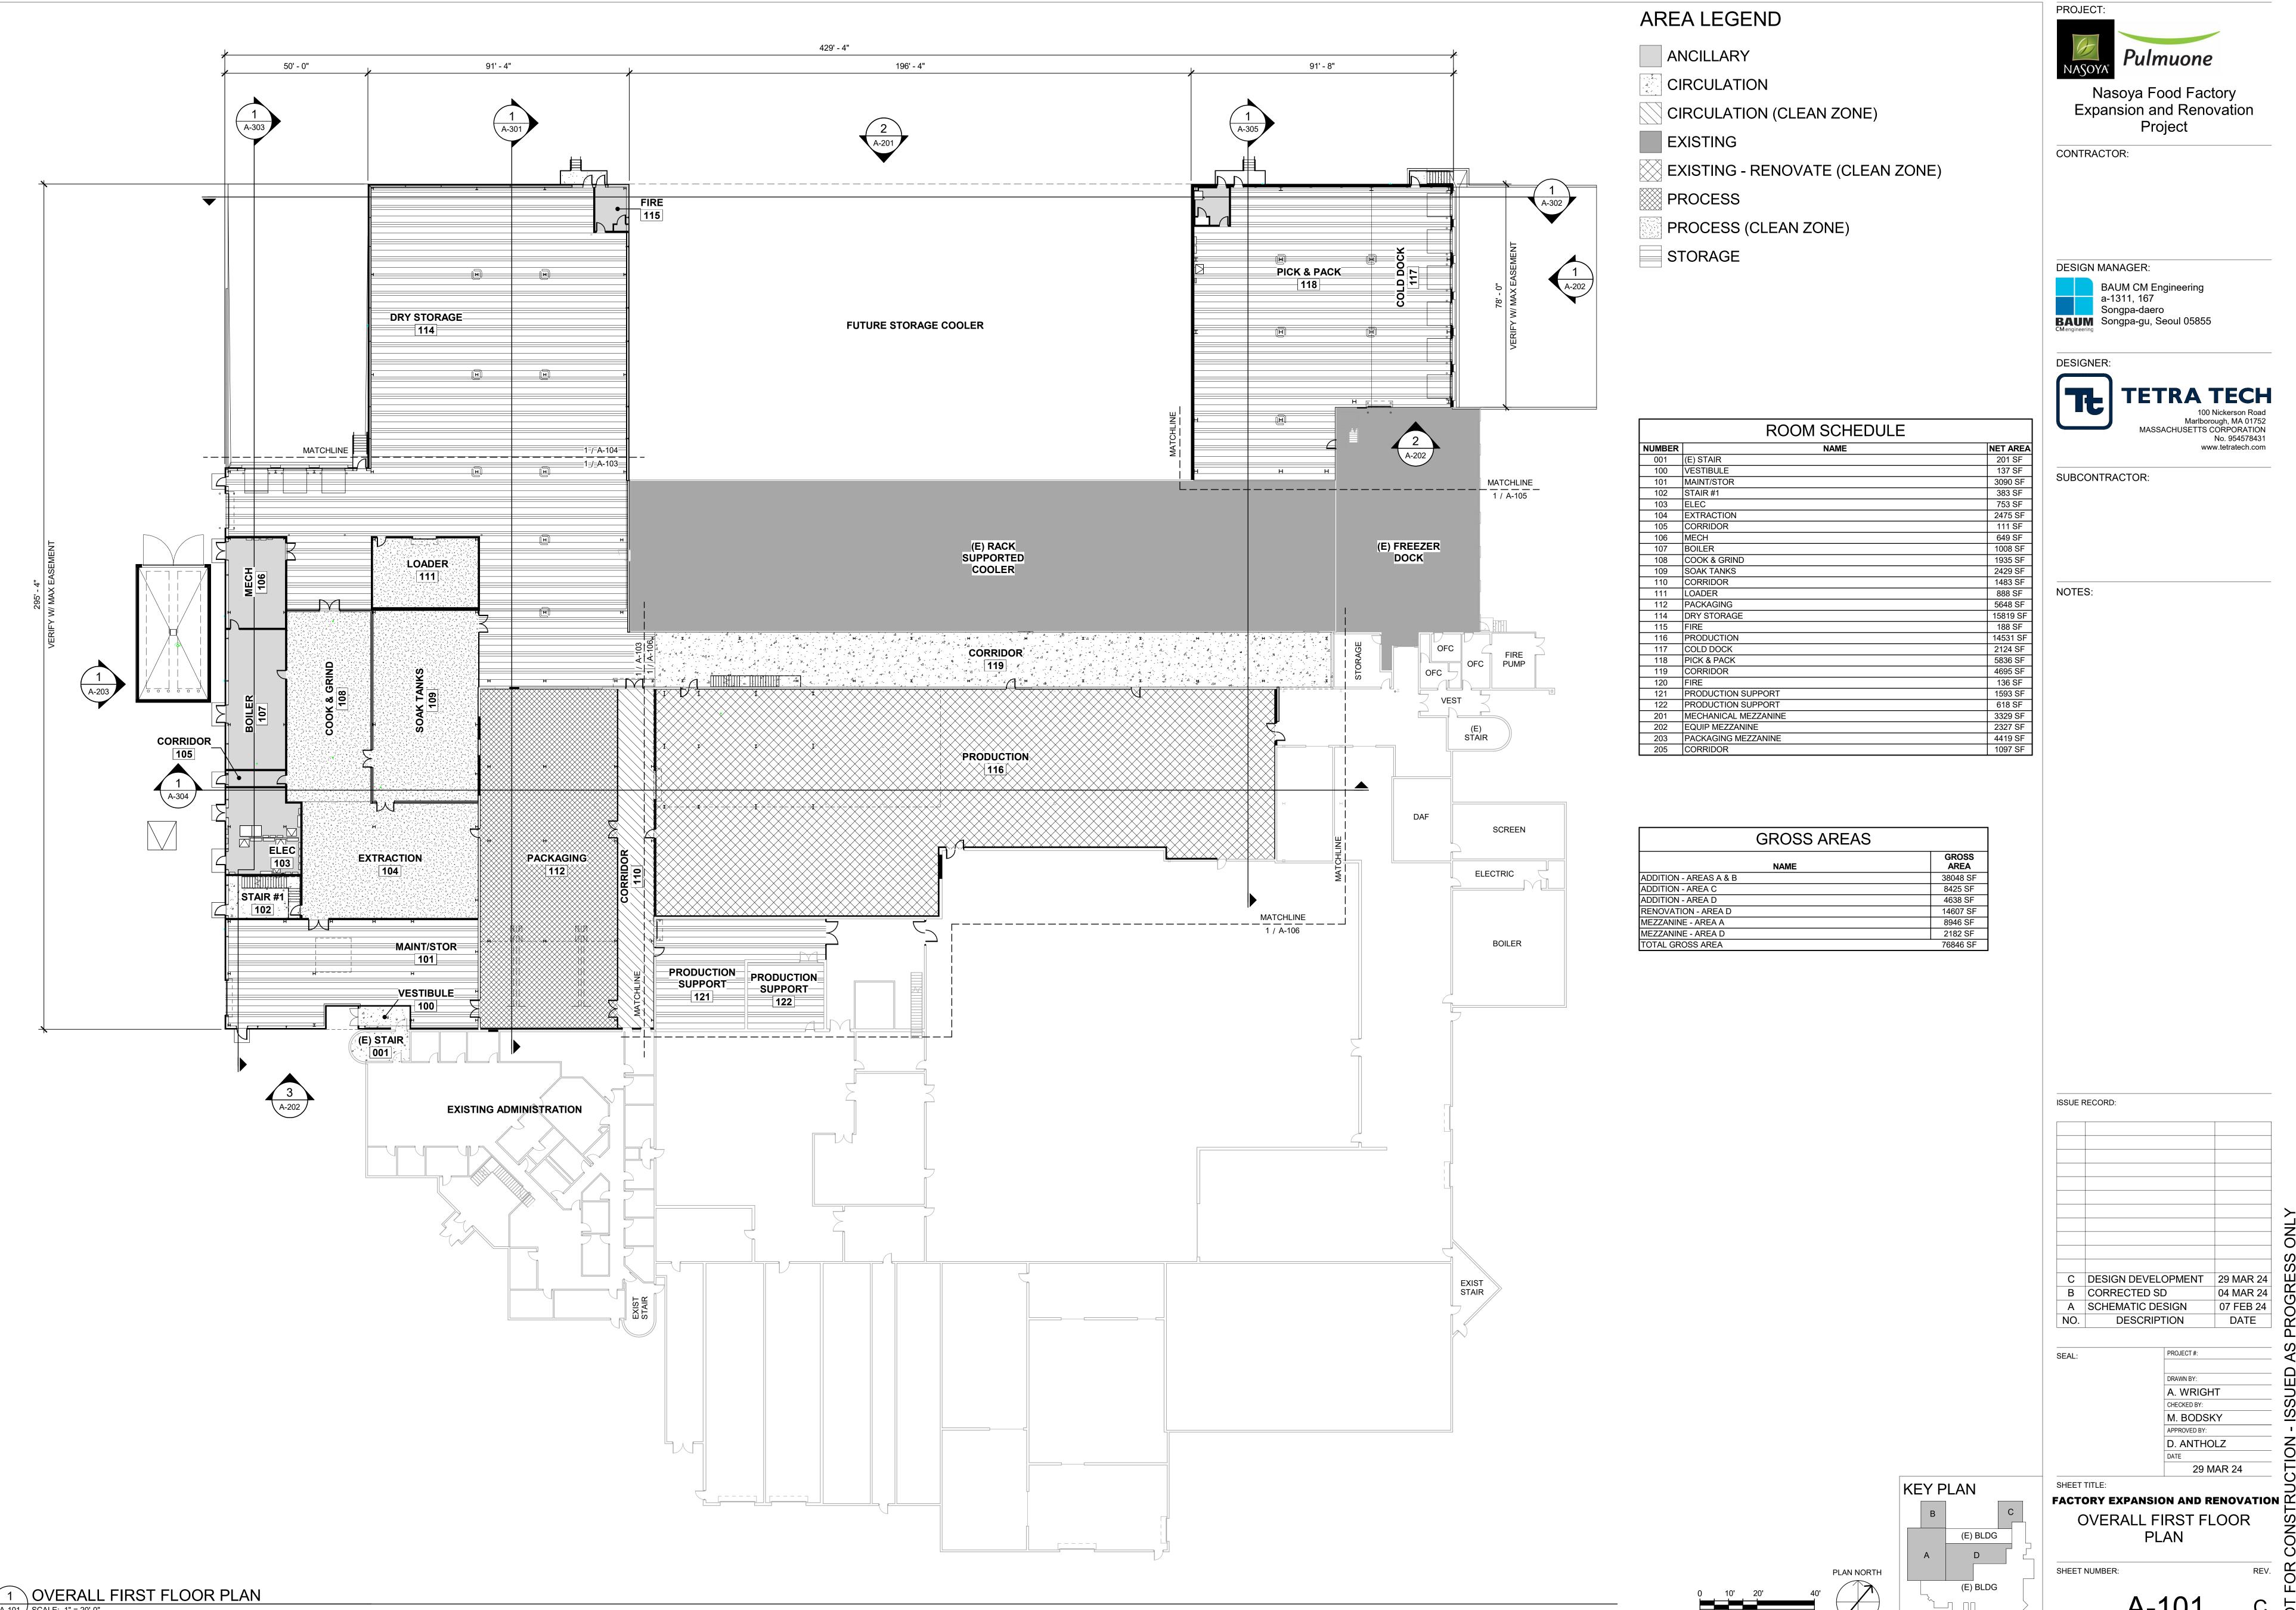

07 FEB 24

DATE

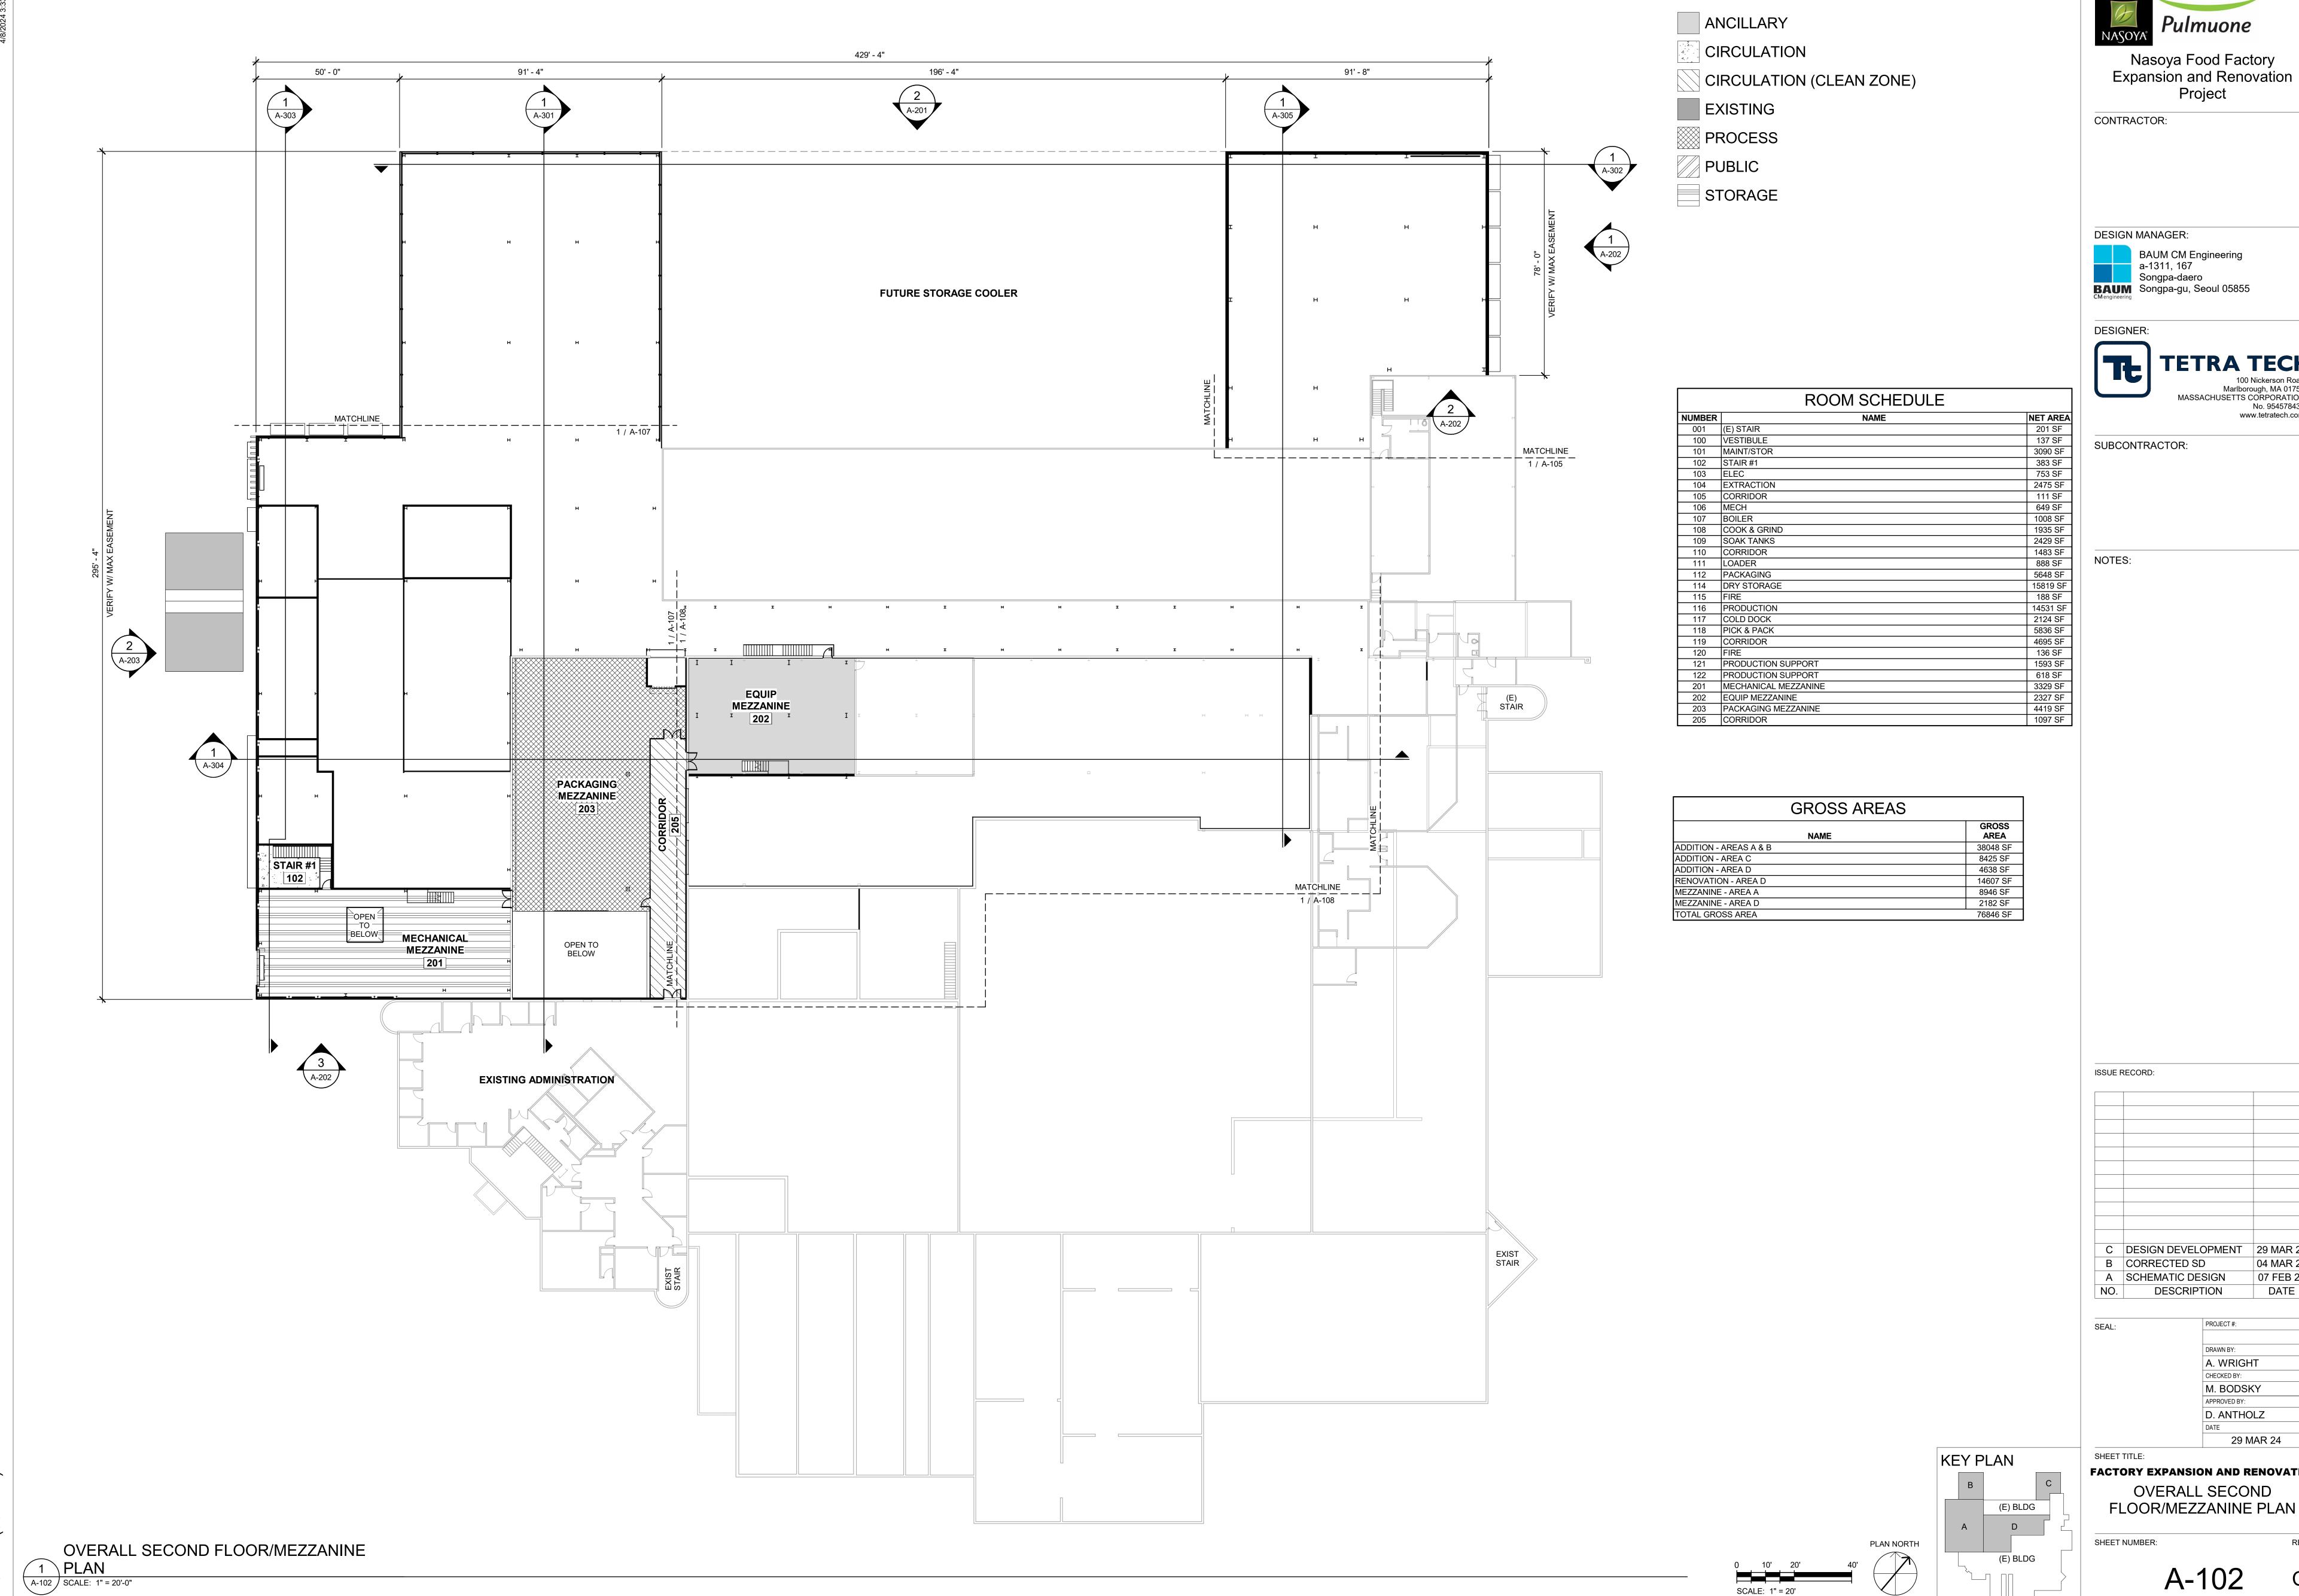

PROJECT:

AREA LEGEND

Project

Marlborough, MA 01752
MASSACHUSETTS CORPORATION

No. 954578431

www.tetratech.com

07 FEB 24 DESCRIPTION DATE


M. BODSKY D. ANTHOLZ


29 MAR 24

SHEET TITLE:

OVERALL SECOND

FLOOR/MEZZANINE PLAN

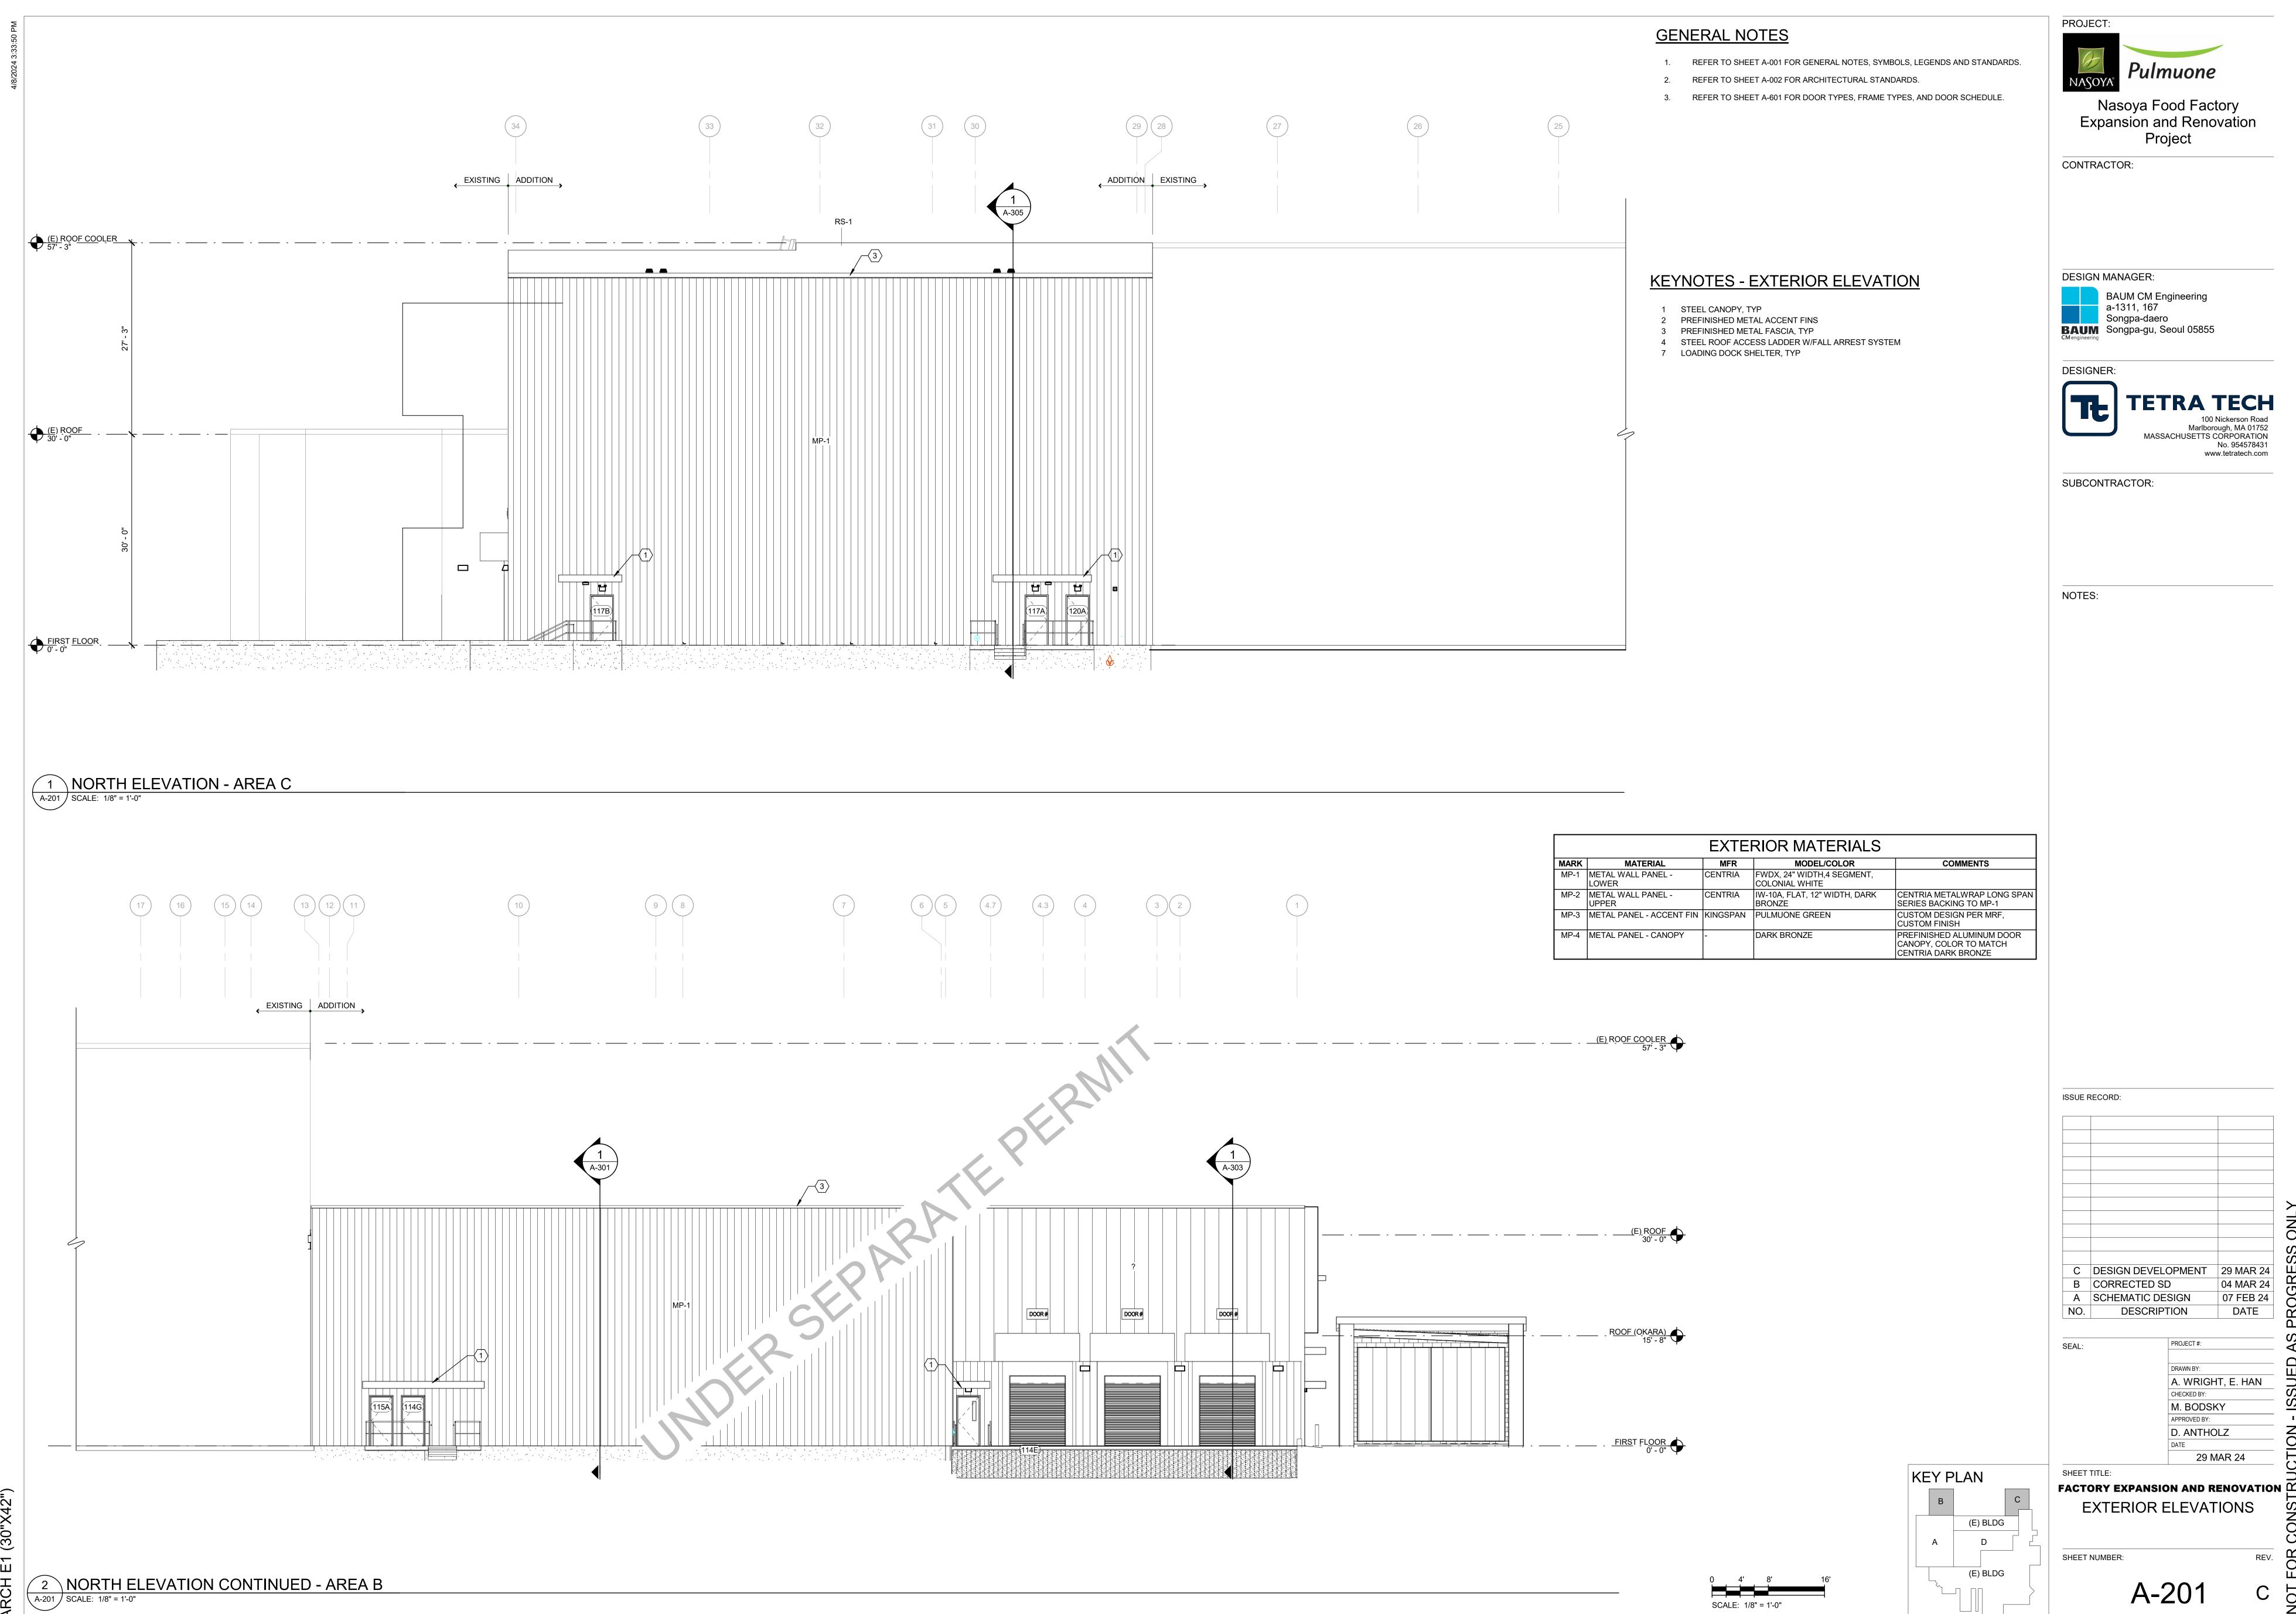

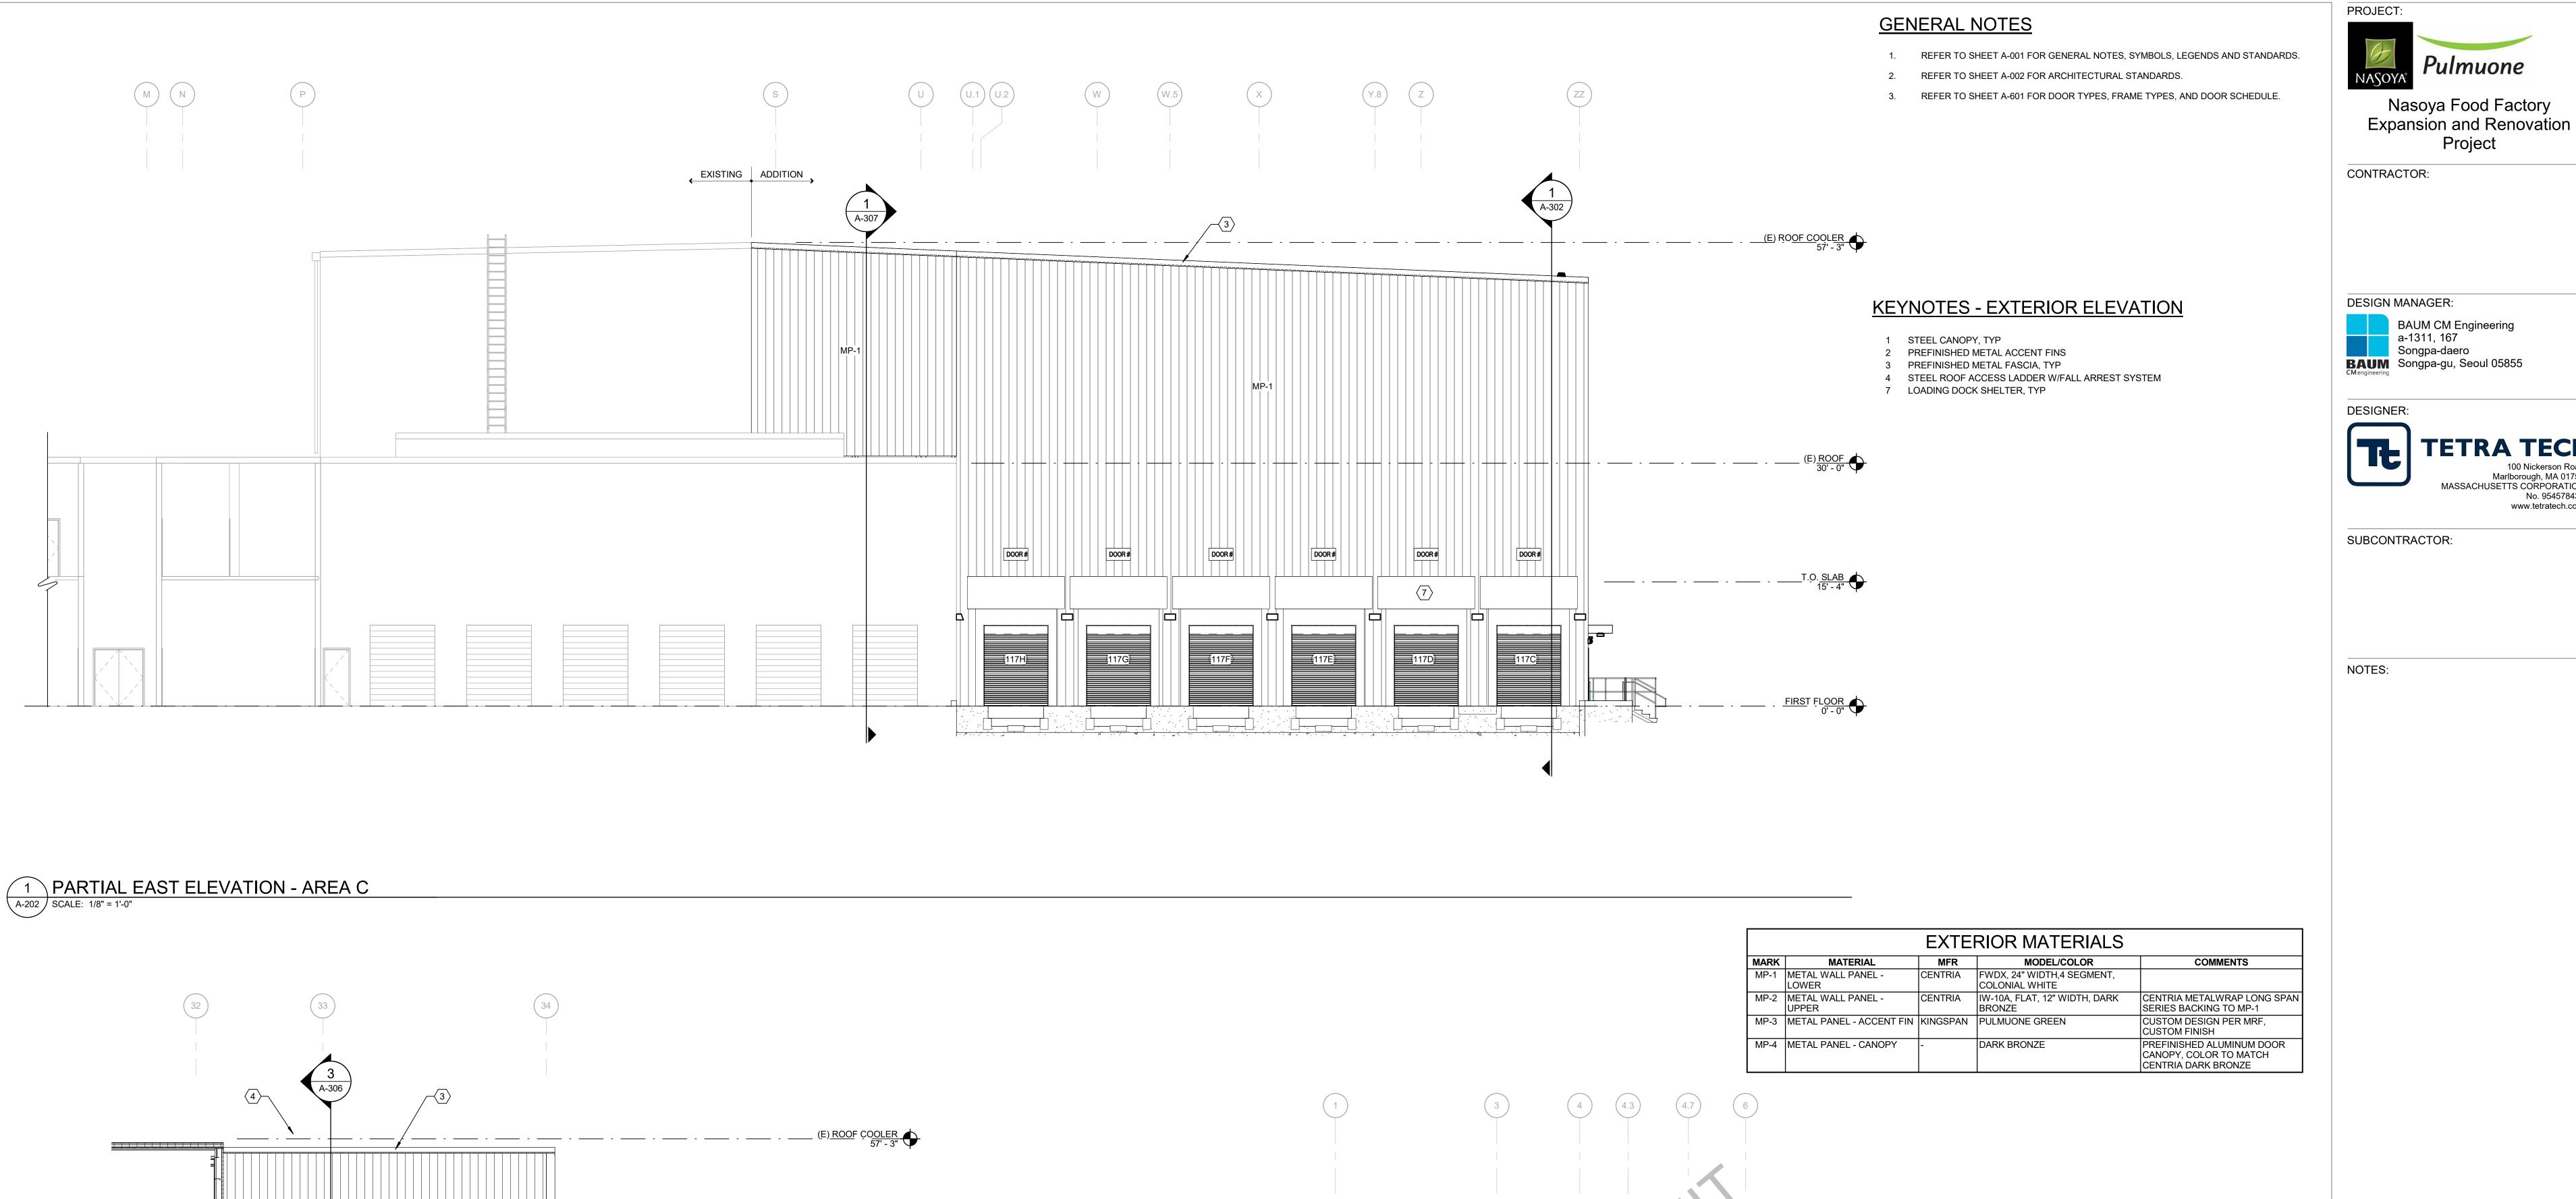

ISSUE RECORD: C DESIGN DEVELOPMENT B CORRECTED SD 07 FEB 24

Project

Marlborough, MA 01752
MASSACHUSETTS CORPORATION

No. 954578431 www.tetratech.com

A SCHEMATIC DESIGN DESCRIPTION DATE

KEY PLAN

(E) BLDG

(E) BLDG

A. WRIGHT, E. HAN M. BODSKY D. ANTHOLZ

29 MAR 24

SHEET TITLE: FACTORY EXPANSION AND RENOVATION u**EXTERIOR ELEVATIONS** 

SHEET NUMBER:

3 PARTIAL SOUTH ELEVATION - AREA A

A-202 SCALE: 1/8" = 1'-0"

PARTIAL SOUTH ELEVATION - AREA C

SCALE: 1/8" = 1'-0"

## **GENERAL NOTES**

- REFER TO SHEET A-001 FOR GENERAL NOTES, SYMBOLS, LEGENDS AND STANDARDS.
- REFER TO SHEET A-002 FOR ARCHITECTURAL STANDARDS.
- REFER TO SHEET A-601 FOR DOOR TYPES, FRAME TYPES, AND DOOR SCHEDULE.




Nasoya Food Factory Expansion and Renovation Project

CONTRACTOR:

## **KEYNOTES - EXTERIOR ELEVATION**

- 1 STEEL CANOPY, TYP
- 2 PREFINISHED METAL ACCENT FINS
- 3 PREFINISHED METAL FASCIA, TYP 4 STEEL ROOF ACCESS LADDER W/FALL ARREST SYSTEM
- 7 LOADING DOCK SHELTER, TYP

**DESIGN MANAGER:** 

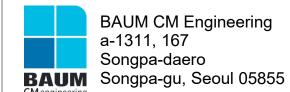

DESIGNER:




No. 954578431 www.tetratech.com

SUBCONTRACTOR:

NOTES:

**EXTERIOR MATERIALS** MODEL/COLOR COMMENTS FWDX, 24" WIDTH,4 SEGMENT, COLONIAL WHITE MP-1 METAL WALL PANEL -MP-2 METAL WALL PANEL -CENTRIA IW-10A, FLAT, 12" WIDTH, DARK CENTRIA METALWRAP LONG SPAN SERIES BACKING TO MP-1 UPPER MP-3 METAL PANEL - ACCENT FIN KINGSPAN PULMUONE GREEN CUSTOM DESIGN PER MRF, CUSTOM FINISH PREFINISHED ALUMINUM DOOR CANOPY, COLOR TO MATCH MP-4 METAL PANEL - CANOPY CENTRIA DARK BRONZE

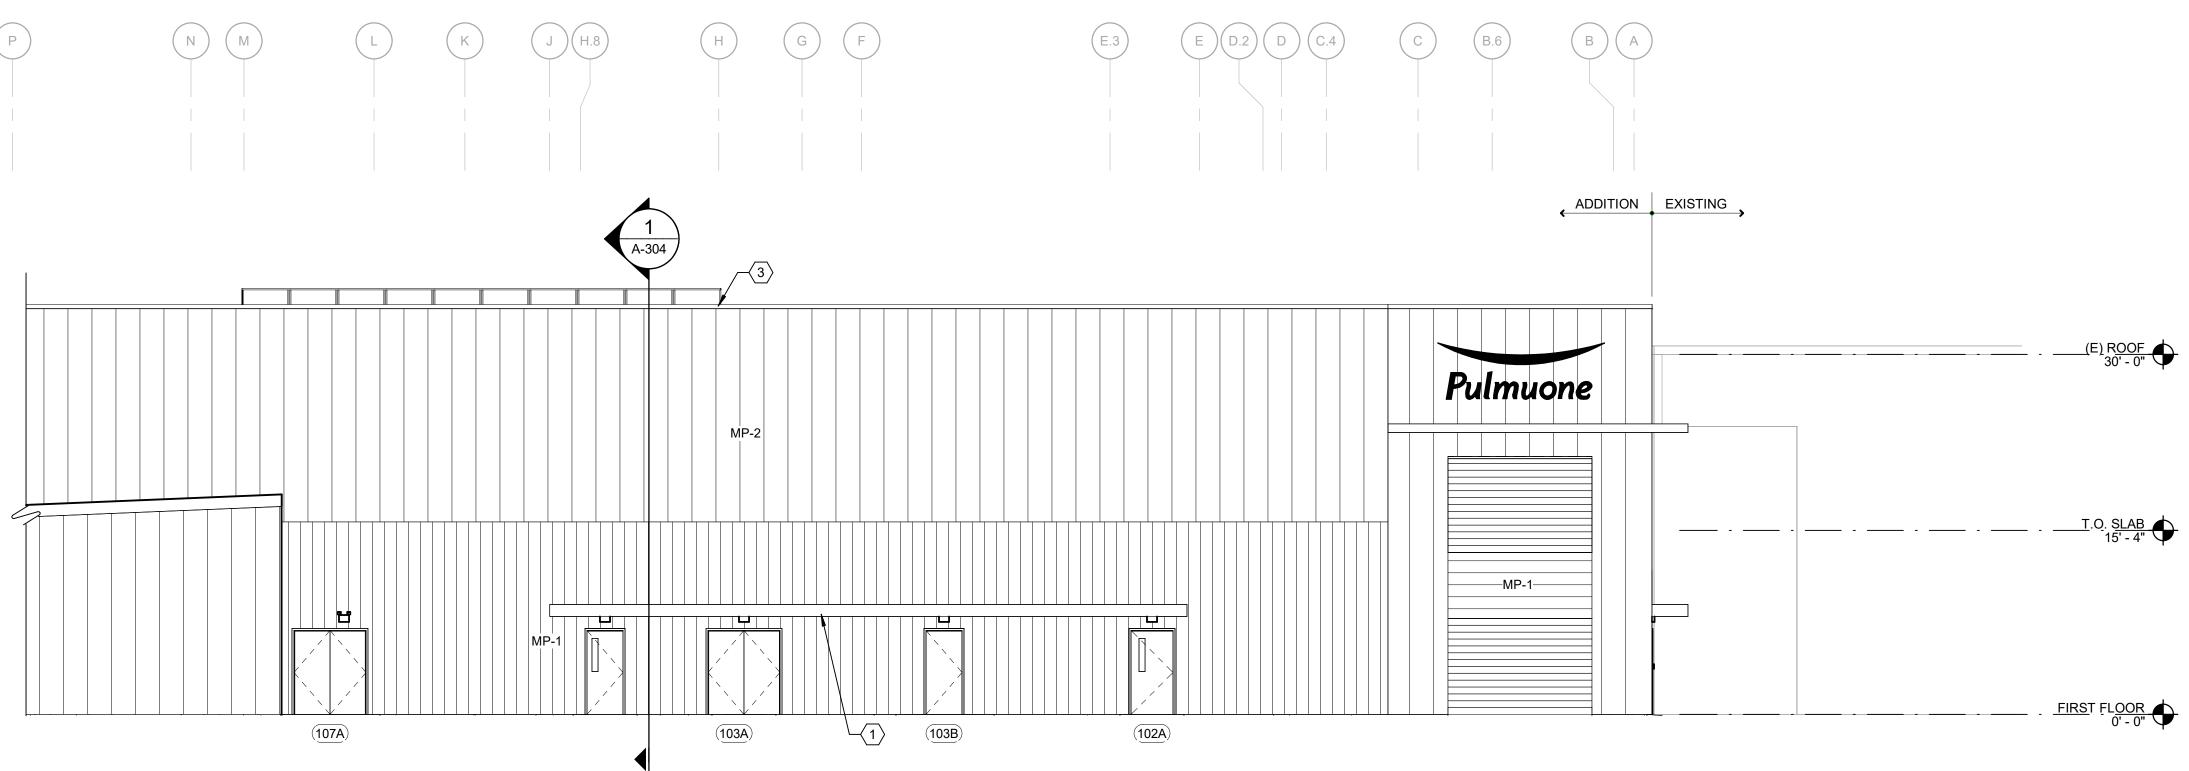

C DESIGN DEVELOPMENT B CORRECTED SD A SCHEMATIC DESIGN DESCRIPTION SHEET TITLE:

ISSUE RECORD:

**KEY PLAN** (E) BLDG (E) BLDG

FACTORY EXPANSION AND RENOVATION u**EXTERIOR ELEVATIONS** 

SHEET NUMBER:

07 FEB 24

DATE

A. WRIGHT, E. HAN

29 MAR 24

M. BODSKY

D. ANTHOLZ

2 WEST ELEVATION CONTINUED - AREA A

SCALE: 1/8" = 1'-0"

1 WEST ELEVATION - AREA A & B
SCALE: 1/8" = 1'-0"

